

ACADEMY OF WARREN
BUILDING “B”

MULTI-PURPOSE ROOM ADDITION ACADEMY OF WARREN

13943 E. EIGHT MILE RD.
WARREN, MICHIGAN 48089

PROJECT MANAGER

MICHAEL W. BEAL
CONSTRUCTION DESIGN SERVICES
1109 FAIRWAY DRIVE
LINDEN, MI. 48451
PHONE/FAX: (810) 735-7512



5859 SHERMAN ROAD • SAGINAW, MICHIGAN 48604
PHONE (989) 752-6500 • FAX (989) 752-6500
TOLL FREE (888) 752-6500

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ARCHITECTURAL	
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MECHANICAL

MI	X
MDI	X

ELECTRICAL

E1	X
E2	X

LEGAL DESCRIPTION

LAND SITUATED IN THE CITY OF WARREN, COUNTY OF MACOMB, STATE OF MICHIGAN, DESCRIBED AS:

THE EAST 12.50 ACRES OF THAT PART OF THE SOUTHWEST 1/4 OF SECTION 36, TOWN 1 NORTH, RANGE 12 EAST, WHICH LIES NORTH OF THE NORTH LINE OF EAST EIGHT MILE ROAD (204 FEET WIDE), CITY OF WARREN, WARREN TOWNSHIP, MACOMB COUNTY, MICHIGAN, MORE PARTICULARLY DESCRIBED AS FOLLOWS: COMMENCING AT THE SOUTHWEST CORNER OF SECTION 36, TOWN 1 NORTH, RANGE 12 EAST, WARREN TOWNSHIP, MACOMB COUNTY, MICHIGAN, THENCE SOUTH 84 DEGREES 52 MINUTES 55 SECONDS EAST ALONG THE SOUTH LINE OF SECTION 36, A DISTANCE OF 1314.74 FEET TO A POINT IN THE WEST LINE OF SUPERVISOR'S PLAT OF HEATH'S FAIRVIEW SUBDIVISION (LIBER 19, PAGE 36 OF PLATS, MACOMB COUNTY RECORDS), EXTENDED SOUTHERLY TO INTERSECT THE SOUTH LINE OF SECTION 36; THENCE NORTH 01 DEGREE 03 MINUTES 45 SECONDS EAST ALONG SAID SUBDIVISION LINE EXTENDED, 120.00 FEET TO THE POINT OF BEGINNING OF THE PARCEL OF LAND HEREIN INTENDED TO BE DESCRIBED; RUNNING THENCE FROM SAID POINT OF BEGINNING NORTH 04 DEGREES 52 MINUTES 55 SECONDS WEST ALONG THE NORTH LINE OF EAST EIGHT MILE ROAD, PARALLEL TO AND DISTANT 120 FEET NORTH OF THE SOUTH LINE OF SECTION 36, A DISTANCE OF 449.25 FEET TO A POINT; THENCE NORTH 01 DEGREE 03 MINUTES 45 SECONDS EAST ALONG A LINE WHICH IS PARALLEL TO THE WEST LINE OF THE AFORESAID SUBDIVISION, A DISTANCE OF 1219.48 FEET TO A POINT IN THE SOUTH LINE OF EASTVIEW SUBDIVISION (LIBER 38, PAGE 4 OF PLATS, MACOMB COUNTY RECORDS); THENCE SOUTH 84 DEGREES 55 MINUTES 15 SECONDS EAST ALONG THE SOUTH LINE OF SAID EASTVIEW SUBDIVISION, SAID LINE BEING ALSO THE NORTH LINE OF THE SOUTHWEST 1/4 OF THE SOUTHWEST 1/4 OF SECTION 36, A DISTANCE OF 449.25 FEET TO THE INTERSECTION OF SAID LINE WITH THE WEST LINE OF SUPERVISOR'S PLAT OF HEATH'S FAIRVIEW SUBDIVISION; THENCE SOUTH 01 DEGREE 03 MINUTES 45 SECONDS WEST ALONG THE WEST LINE OF SAID SUBDIVISION, SAID LINE BEING ALSO THE EAST LINE OF THE SOUTHWEST 1/4 OF SECTION 36, A DISTANCE OF 1216.19 FEET TO THE POINT OF BEGINNING.

SITE CONTAINING: 544,506 S.F. OR 12.50 ACRES.

CODE REVIEW INFORMATION

APPLICABLE CODES: ALL WORK UNDER THIS CONTRACT SHALL COMPLY WITH THE PROVISIONS OF THE SPECIFICATIONS & DRAWINGS, AND SHALL SATISFY ALL APPLICABLE CODES, ORDINANCES, AND REGULATIONS OF ALL GOVERNING BODIES INVOLVED. ALL PERMITS AND LICENSES NECESSARY FOR THE PROPER EXECUTION OF THE WORK SHALL BE SECURED AND PAID FOR BY THE CONTRACTOR INVOLVED. APPLICABLE CODES INCLUDE, BUT ARE NOT LIMITED TO THE FOLLOWING:

1. BUILDING & STRUCTURAL	MICHIGAN BUILDING CODE	2003
2. PLUMBING	MICHIGAN PLUMBING CODE	2003
3. MECHANICAL	MICHIGAN MECHANICAL CODE	2003
4. ELECTRICAL	N.E.C.	2002
5. BARRIER FREE ACCESS	MICHIGAN BUILDING CODE	2003
6. NFPA 101	1997 EDITION	

SITE AND BUILDING DATA



1. ZONING	C-2, COMMERCIAL
2. BUILDING AREA	3,165 SQ. FT. GROSS
3. BUILDING HT.	18'-0"
4. BUILDING USE GROUP	E - EDUCATIONAL (K-6)
5. TYPE OF CONSTRUCTION:	II B
6. BUILDING IS FULLY FIRE SUPPRESSED	


ABBREVIATIONS

∅	AT ANGLE	INT.	INTERIOR
<	ANCHOR BOLT	JAN.	JANITOR
A.B.	AIR CONDITIONING	J.B./J. BOX	JUNCTION BOX
A.C.	ACOUSTICAL	LAM.	LAMINATE
ACGUST.		LAV.	LAVATORY
ADJ.	ADJUSTABLE	L.L.	LANDLORD
A.F.F.	ABOVE FINISH FLOOR	MAS.	MASONRY
ALT.	ALTERNATE	MATL.	MATERIAL
ALUM.	ALUMINUM	MAX.	MAXIMUM
ARCH.	ARCHITECTURAL	MECH.	MECHANICAL
BLKG.	BLOCKING	MET.	METAL
B.M.	BENCH MARK	MISC.	MISCELLANEOUS
BOT.	BOTTOM	MIN.	MINIMUM
BRG.	BEARING	M.O.	MASONRY OPENING
B.U.R.	BUILT UP ROOF	N.I.C.	NOT IN CONTRACT
CHNL.	CHANNEL	N.T.S.	NOT TO SCALE
C.T.	CERAMIC TILE	O.C.	ON CENTER
C.J.	CONTROL JOINT	O.D.	OUTSIDE DIAMETER
C.L./C.	CENTER LINE	OPNG.	OPENING
CLG.	CEILING	OPP. HD.	OPPOSITE HAND
C.O.	CLEAN OUT	PL.LAM.	PLASTIC LAMINATE
COL.	COLUMN	FL/PL	PLYWOOD
CONC.	CONCRETE	FR.	PAIR
CONST. JT.	CONSTRUCTION JOINT	R.A.	RETURN AIR
CONT.	CONTINUOUS	R.	RADIUS
DBL.	DOUBLE	R.D.	ROOF DRAIN
DET.	DETAIL	REF.	REFRIGERATOR
DIA./Ø	DIAMETER	REINF.	REINFORCING
DIV.	DIVISION	REQ.	REQUIRED
DN.	DOWN	S.A.	SUPPLY AIR
DW.	DISHWASHER	SFS.	SURFACE FOUR SIDES
D.S.	DOWN SPOUT	S.C.	SOLID CORE
DWS.	DRAWING	SHT.	SHEET
EA.	EACH	SPEC.	SPECIFICATION
E.J.	EXPANSION JOINT	SS.	SERVICE SINK
ELEC.	ELECTRICAL	ST.STL.	STAINLESS STEEL
ELEV.	ELEVATION	STL.	STEEL
EQ.	EQUAL	STOR.	STORAGE
EST.	ESTIMATE	STR.	STRUCTURAL
E.W.	EACH WAY	S.R.F.E.	SEMI-RECESSED FIRE EXTING.
E.W.C.	ELEC. WATER COOLER	T.	THERMOSTAT
EXP.	EXPANSION	T.G.	TOP OF CURB
EXT.	EXTERIOR	TEN.	TENANT
F.E.	SURFACE FIRE EXTINGUISHER	T.G.C.	TENANT'S GEN. CONTR.
FIN.	FINISH FLOOR FINISH	T.P.	TOP OF PAVING
FLR.	FLOOR	TYP.	TYPICAL
F.S.	FLOOR SINK	UN.O.	UNLESS NOTED OTHERWISE
F.B.O.	FURNISHED BY OWNER	V.I.F.	VERIFY IN FIELD
F.D.	FLOOR DRAIN	V.T.R.	VENT THROUGH ROOF
FDN.	FOUNDATION	WH.	WATER HEATER
GA.	GAUGE	WI.	WROUGHT IRON
GALV.	GALVANIZED	WP.	WATER PROOF
G.C.	GENERAL CONTRACTOR	WR.	WATER RESISTANT
G.I.	GALVANIZED IRON	WT.	WEIGHT
H.B.	HOSE BIBB	W'	WITH
H.C.	HOLLOW CORE	W/O	WITHOUT
HDWE.	HARDWARE		
H.M.	HOLLOW METAL		
I.D.	INSIDE DIAMETER		
INSUL.	INSULATION		

DRAWING SYMBOLS

	SECTION CUT
	DETAIL NUMBER
	SHEET REFERENCE NUMBER
	DOOR NUMBER
	ROOM NUMBER
	INTERIOR ELEVATION
	REVISION NUMBER

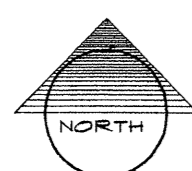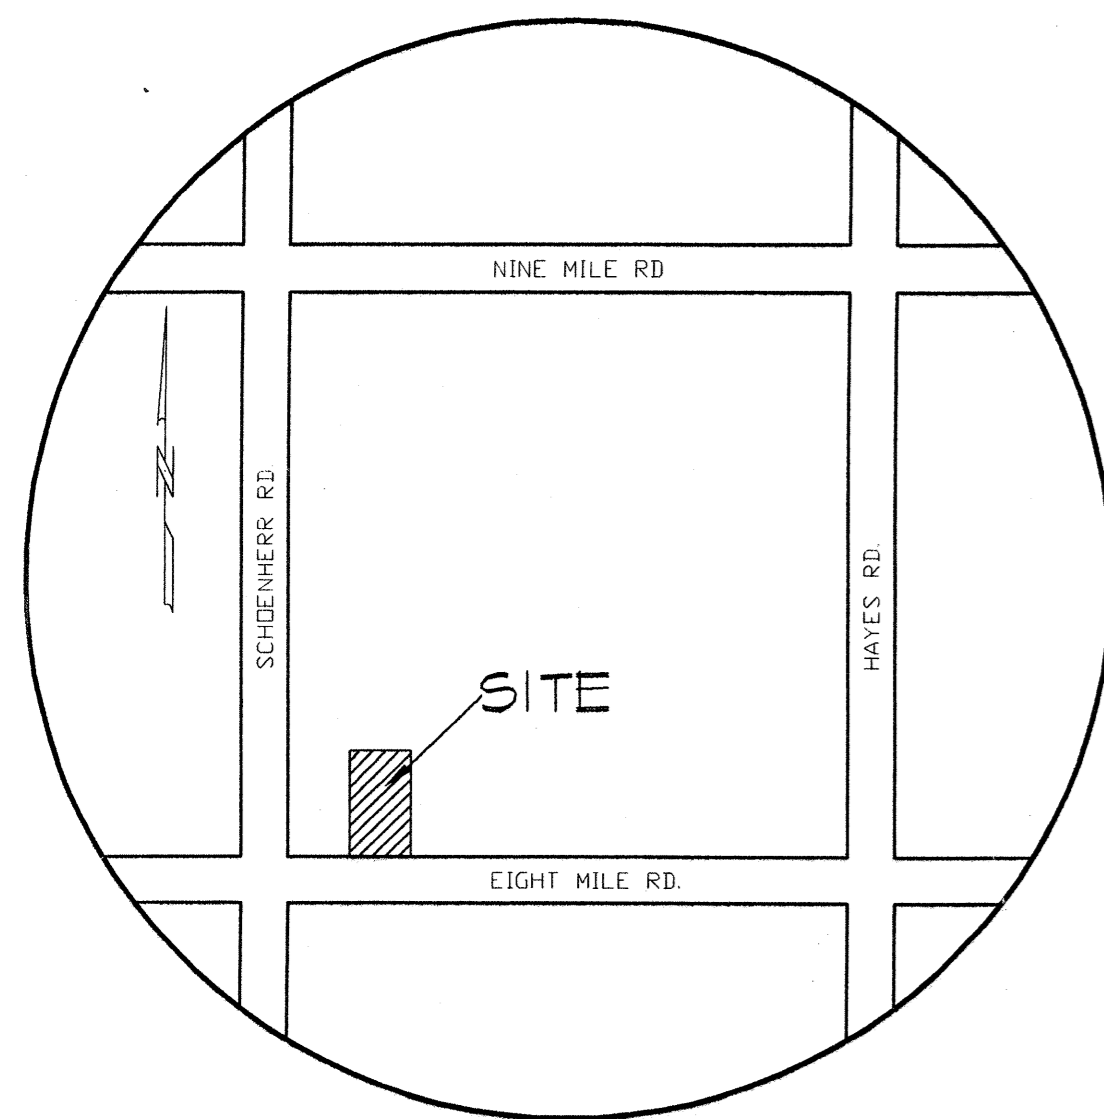

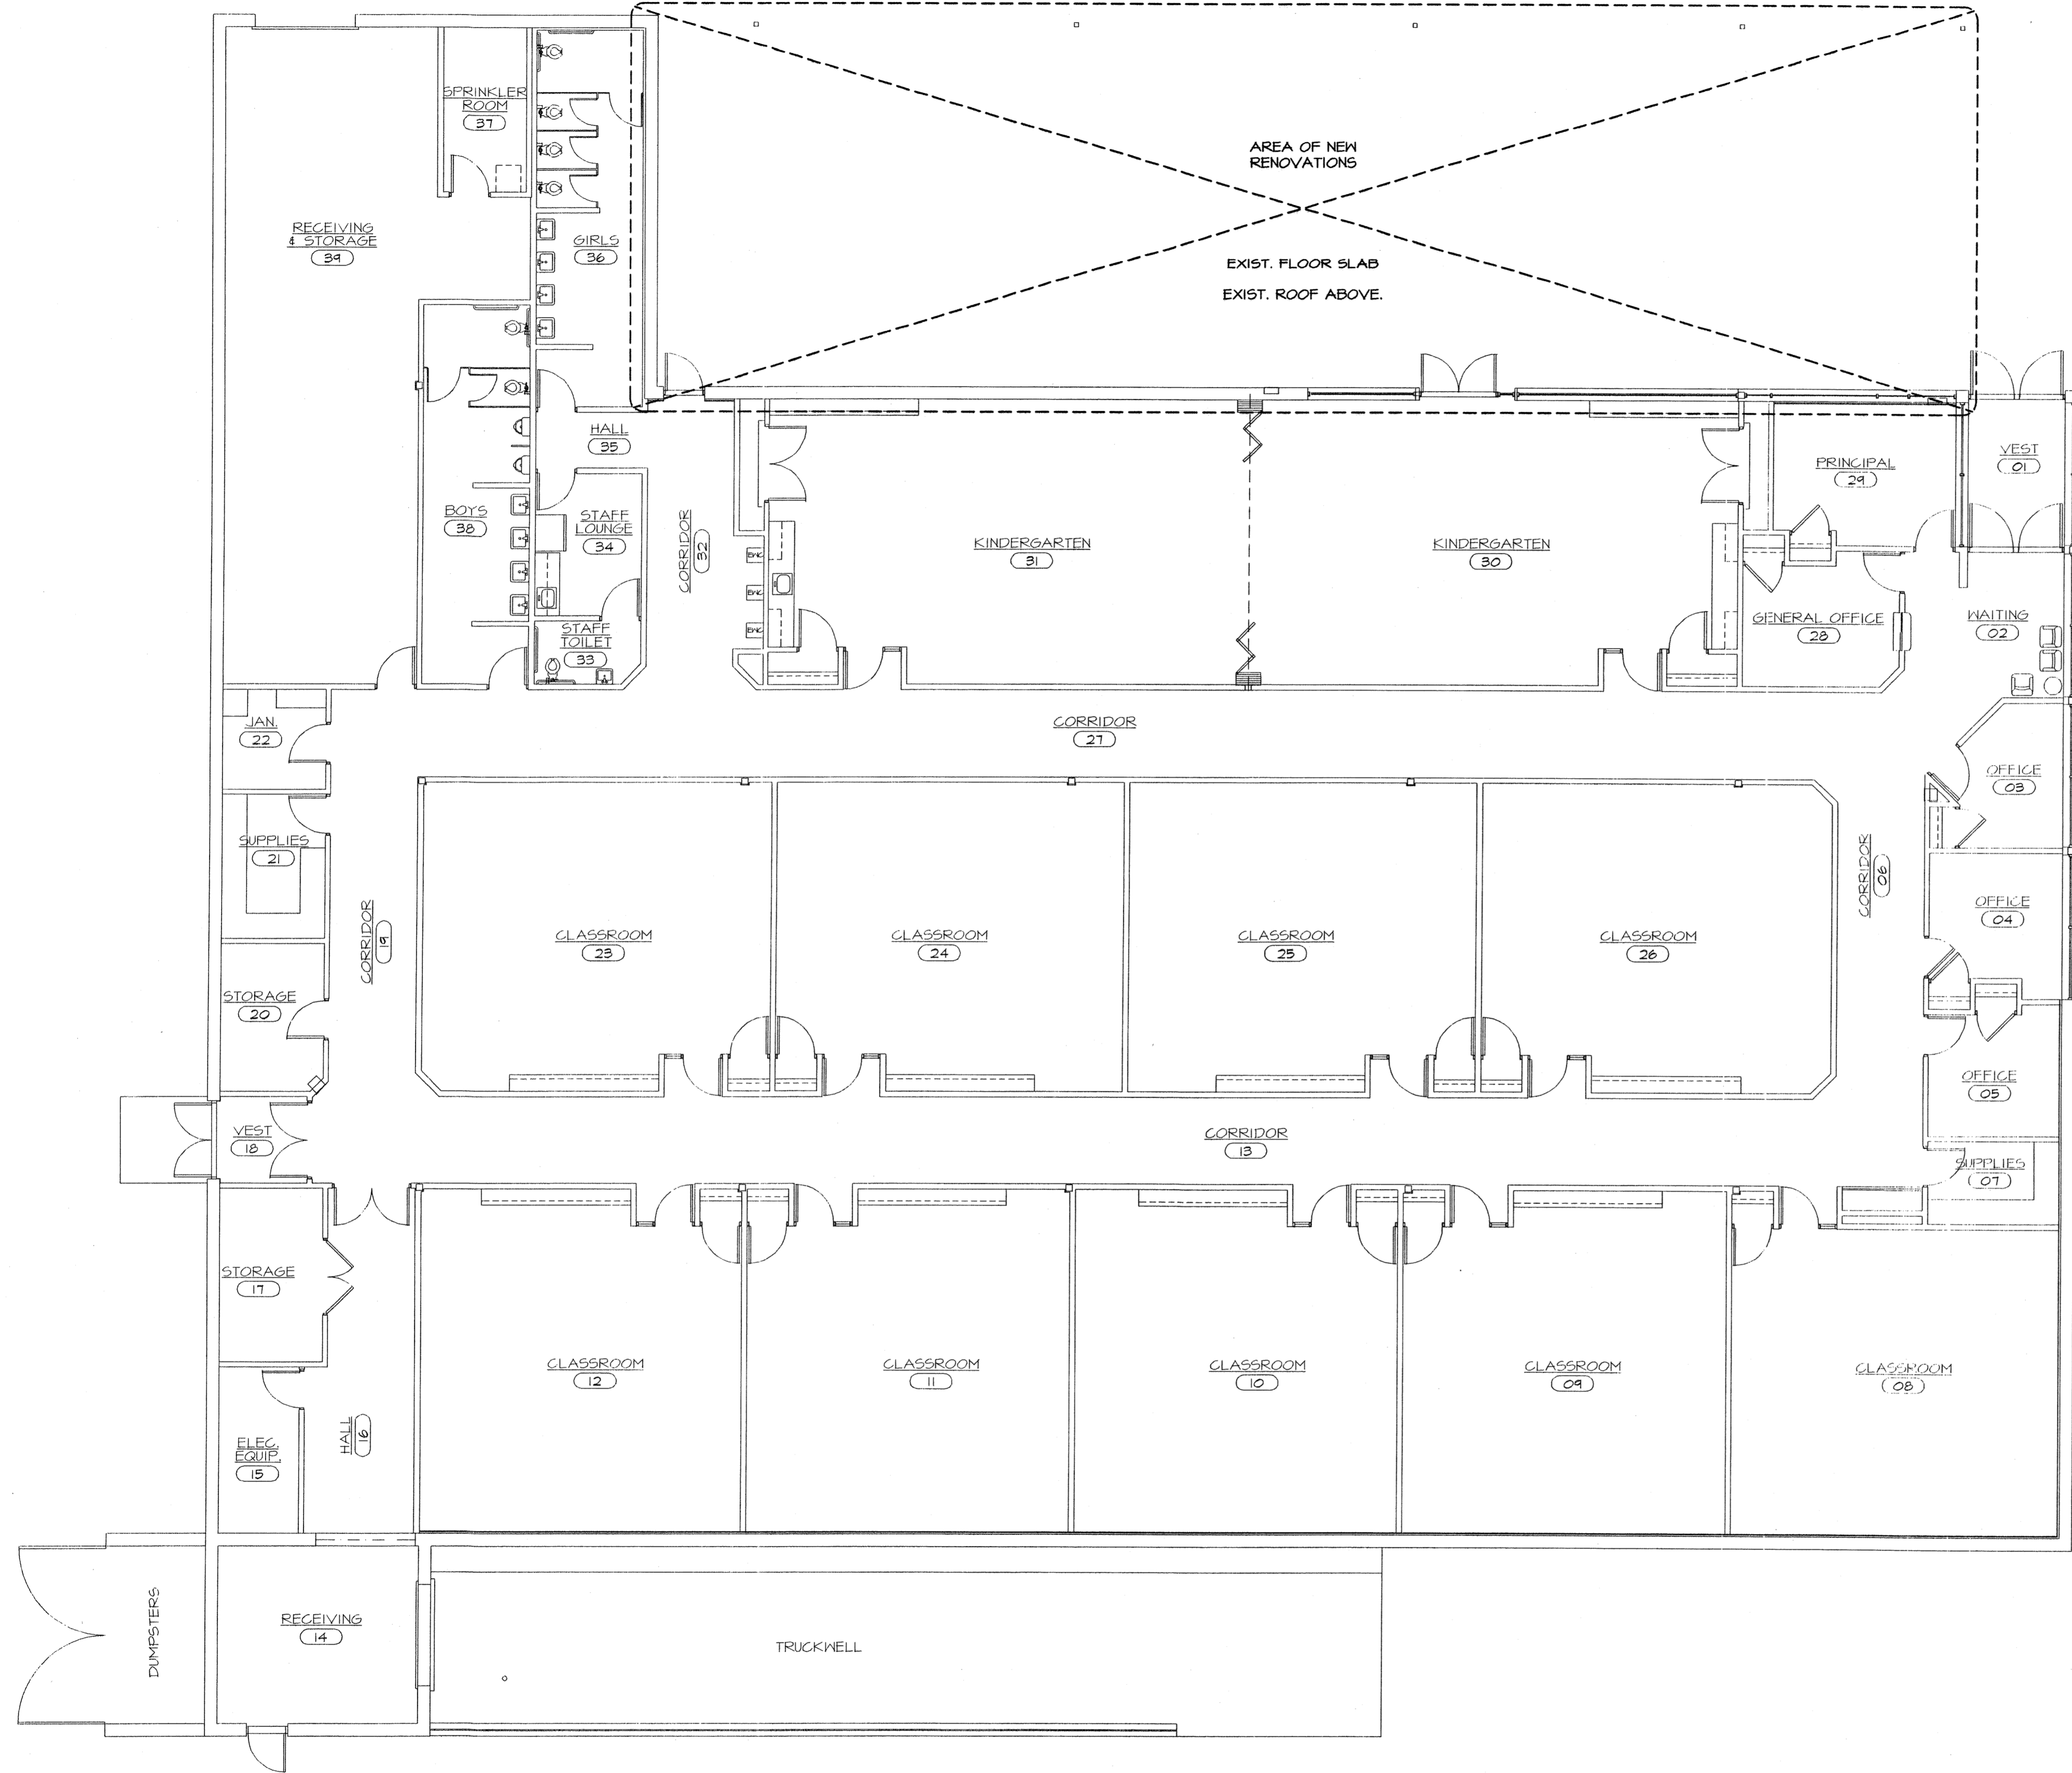

COMPOSITE FLOOR PLAN
 SCALE 1/8" = 1'-0"

PREPARED UNDER THE SUPERVISION OF:

PROJECT LOG

FILE: A1

PROJECT MGR: M.M.B.

DESIGNED BY: M.M.B.

DRAWN BY: M.J.K.

CHECKED BY: J.D.W.

SCALE: 1/8" = 1'-0"

SHEET: **A1 of 6**

OWNER:

**CHARTER SCHOOL
 ADMINISTRATION SERVICES**
 20755 GREENFIELD RD, SUITE 300
 SOUTHFIELD, MICHIGAN 48076
 (248) 789-4401


**MULTI-PURPOSE ROOM ADDITION
 ACADEMY OF WARREN**

13943 E. EIGHT MILE RD.
 WARREN, MICHIGAN 48089


COMPOSITE FLOOR PLAN

**Professional
 Services**
 AN ISO 9001
 CERTIFIED COMPANY
 WWW.WILCOXASSOCIATES.COM


5450 SHERMAN RD, S.W. CORNER, SUITE 1000, ALPHARETTA, GA 30201
 PHONE (888) 732-6500 *FAX (678) 752-6000
 TOLL FREE (888) 732-6500

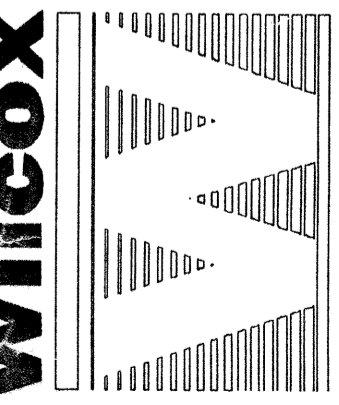

A1

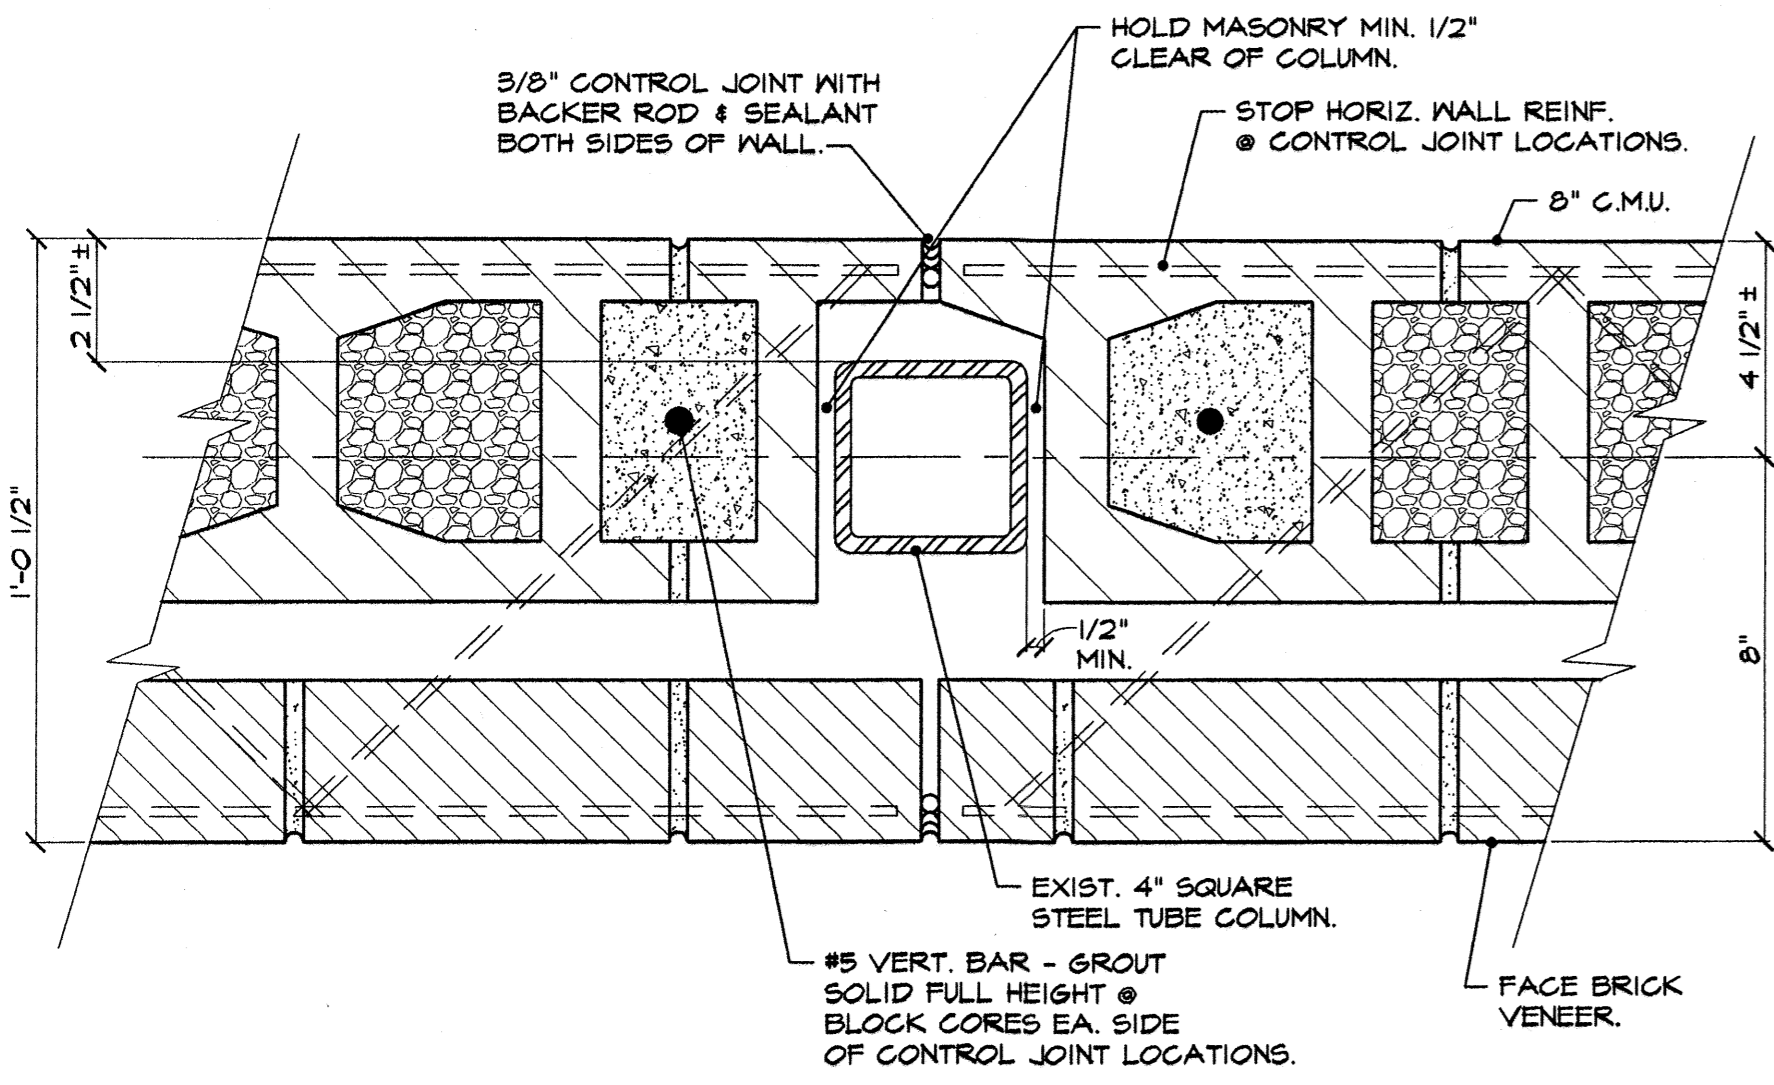


1 TYP. WALL / COLUMN CONTROL JOINT
SCALE: 3" = 1'-0"

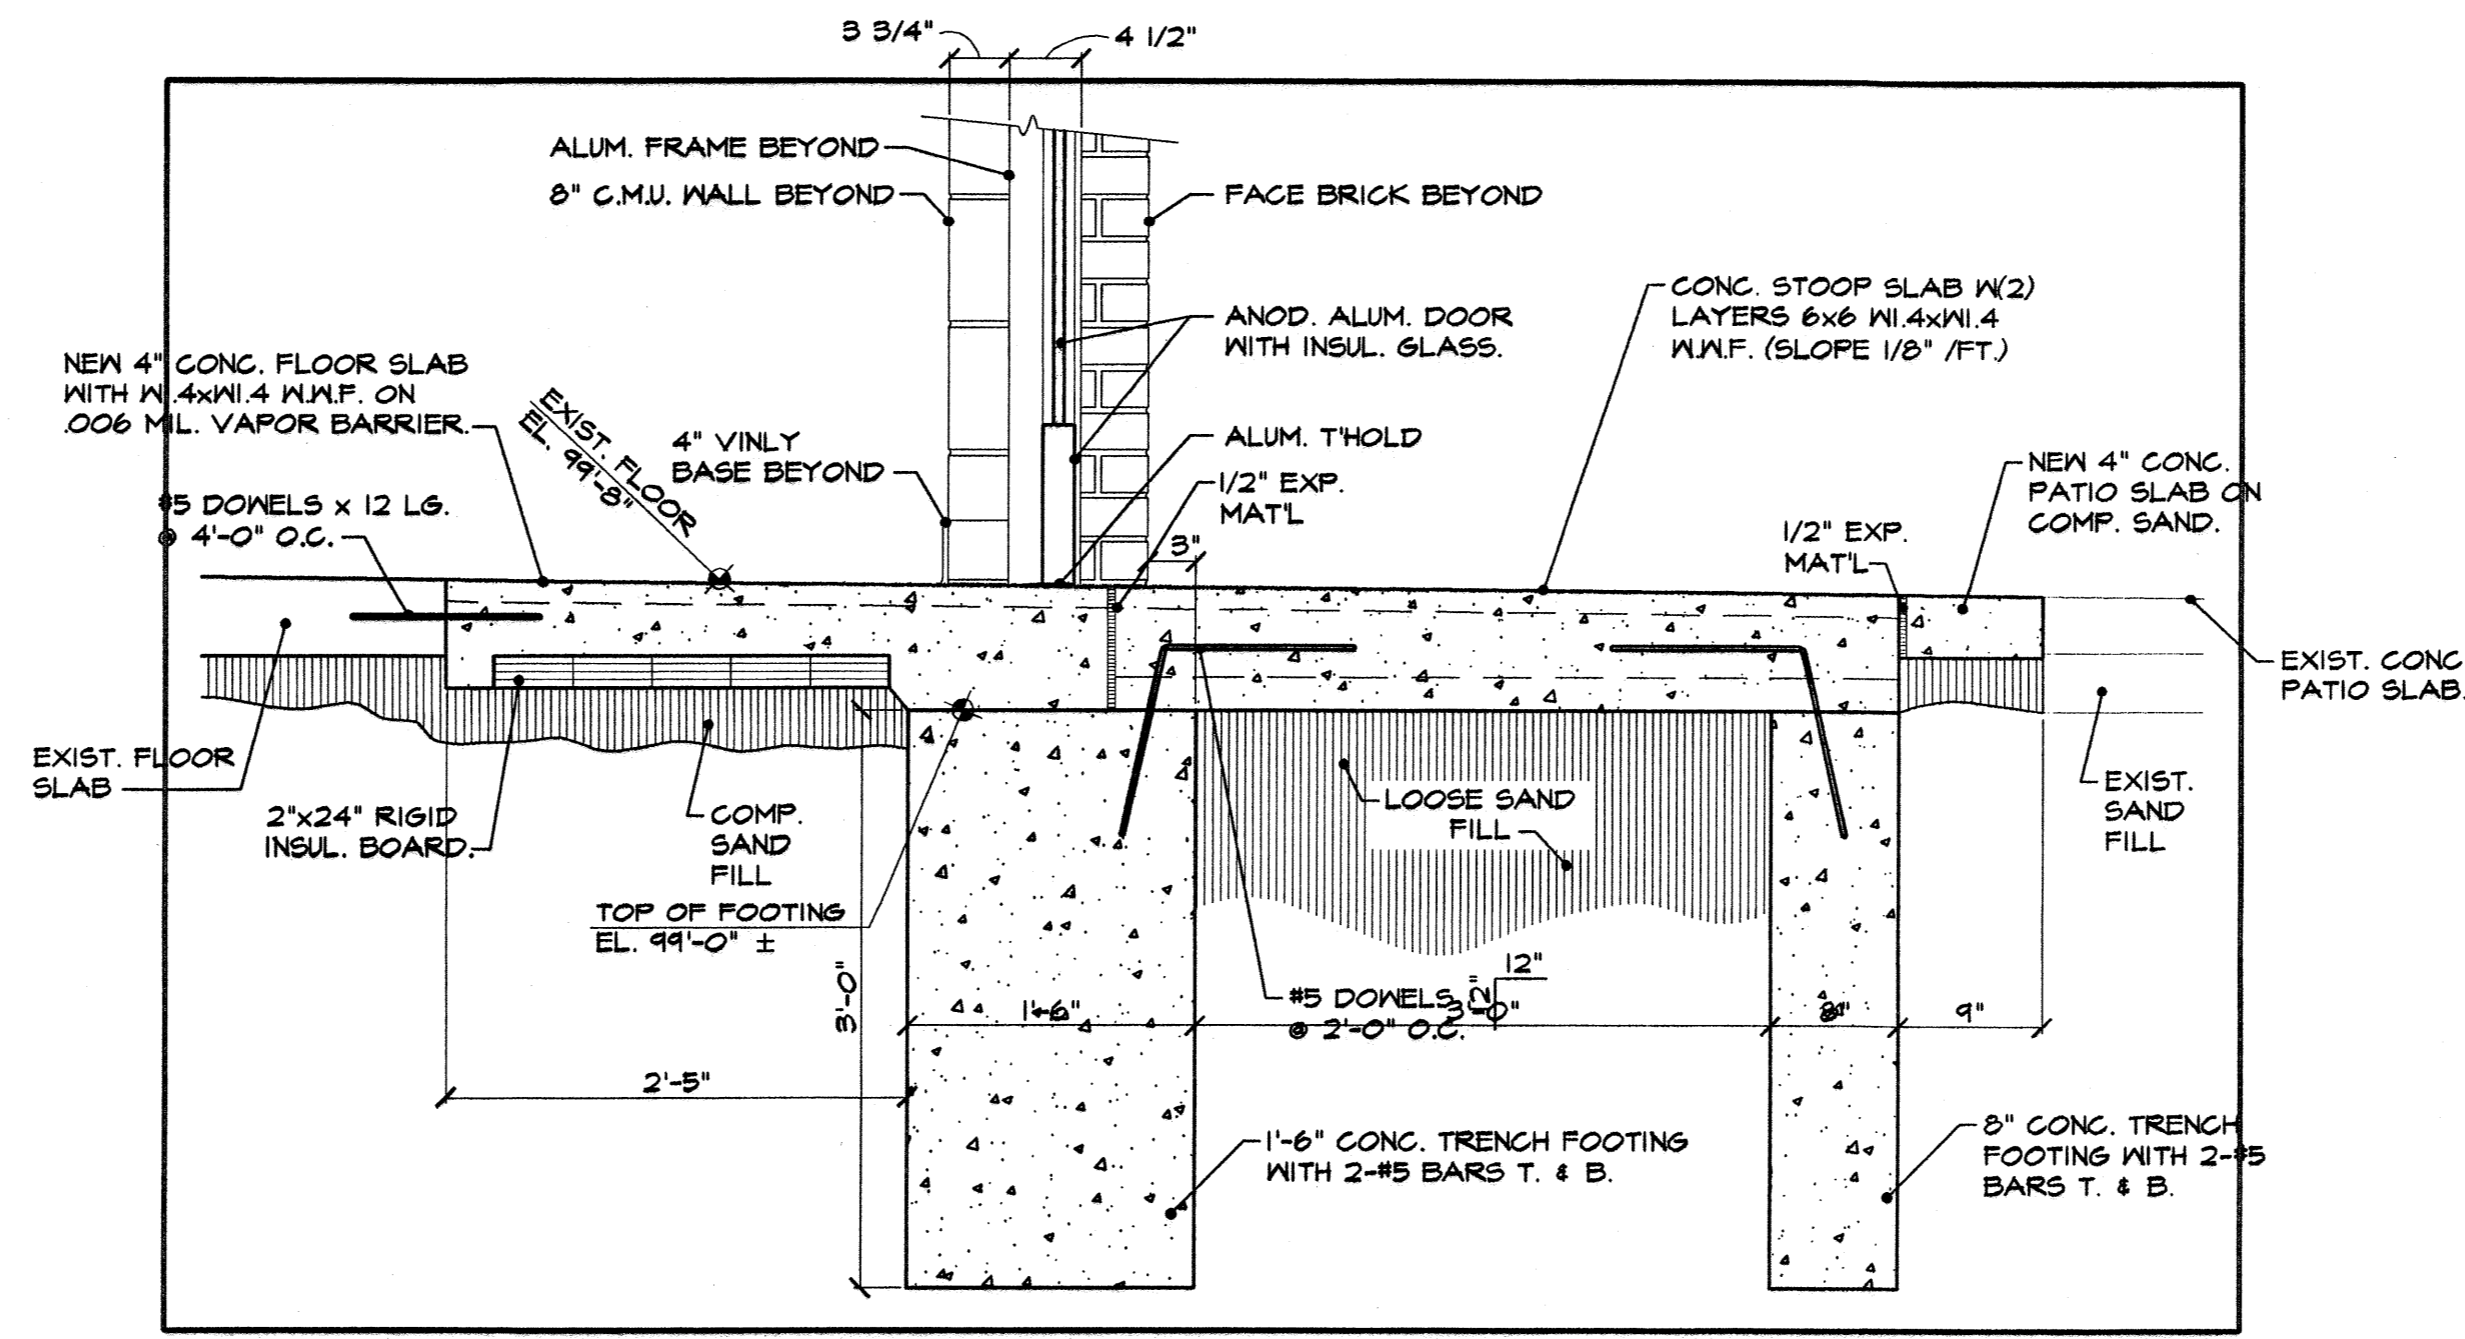

2 DOOR ENTRANCE STOOP DETAIL
SCALE: 3" = 1'-0"

CONSTRUCTION NOTES

- 1 EXISTING 12" FOUNDATION WALL & CONCRETE SPREAD FOOTING BELOW.
- 2 EXISTING CONCRETE COLUMN PIER & CONCRETE SPREAD FOOTING BELOW.
- 3 SAW-CUT & REMOVE EXISTING CONCRETE WALK SLAB.
- 4 SAW-CUT & REMOVE EXISTING CONCRETE FLOOR SLAB.
- 5 INSTALL NEW 1'-6" WIDE x 3'-6" DEEP (MIN) CONCRETE TRENCH FOOTING WITH 2 - #5 CONT. BARS TOP & BOTTOM - DOWEL INTO EXISTING CONCRETE COLUMN PIERS AND EXISTING FOUNDATION WALL.
- 6 INSTALL NEW 4" CONCRETE WALK SLAB ON COMPACTED SAND FILL - PROVIDE CONTROL JOINTS IN NEW SLAB TO MATCH EXISTING LOCATIONS.
- 7 INSTALL NEW 4" CONCRETE FLOOR SLAB WITH 6x6 MIL VAPOR BARRIER ON 4" MIN. COMPACTED SAND FILL - PROVIDE #5 DOWELS x 12" LONG AT 4'-0" O.C. - EPOXY-SET DOWELS IN DRILLED HOLES 6" DEEP AT CENTERLINE OF EXISTING FLOOR SLAB.
- 8 INSTALL NEW 8" WIDE x 3'-6" DEEP (MIN) CONCRETE TRENCH FOOTING WITH #5 BAR CONT. TOP & BOTTOM.
- 9 CONCRETE STOOP SLAB ABOVE WITH 6x6 MIL VAPOR BARRIER ON LOOSE SAND FILL - PROVIDE 1/2" EXPANSION MATERIAL AT PERIMETER.

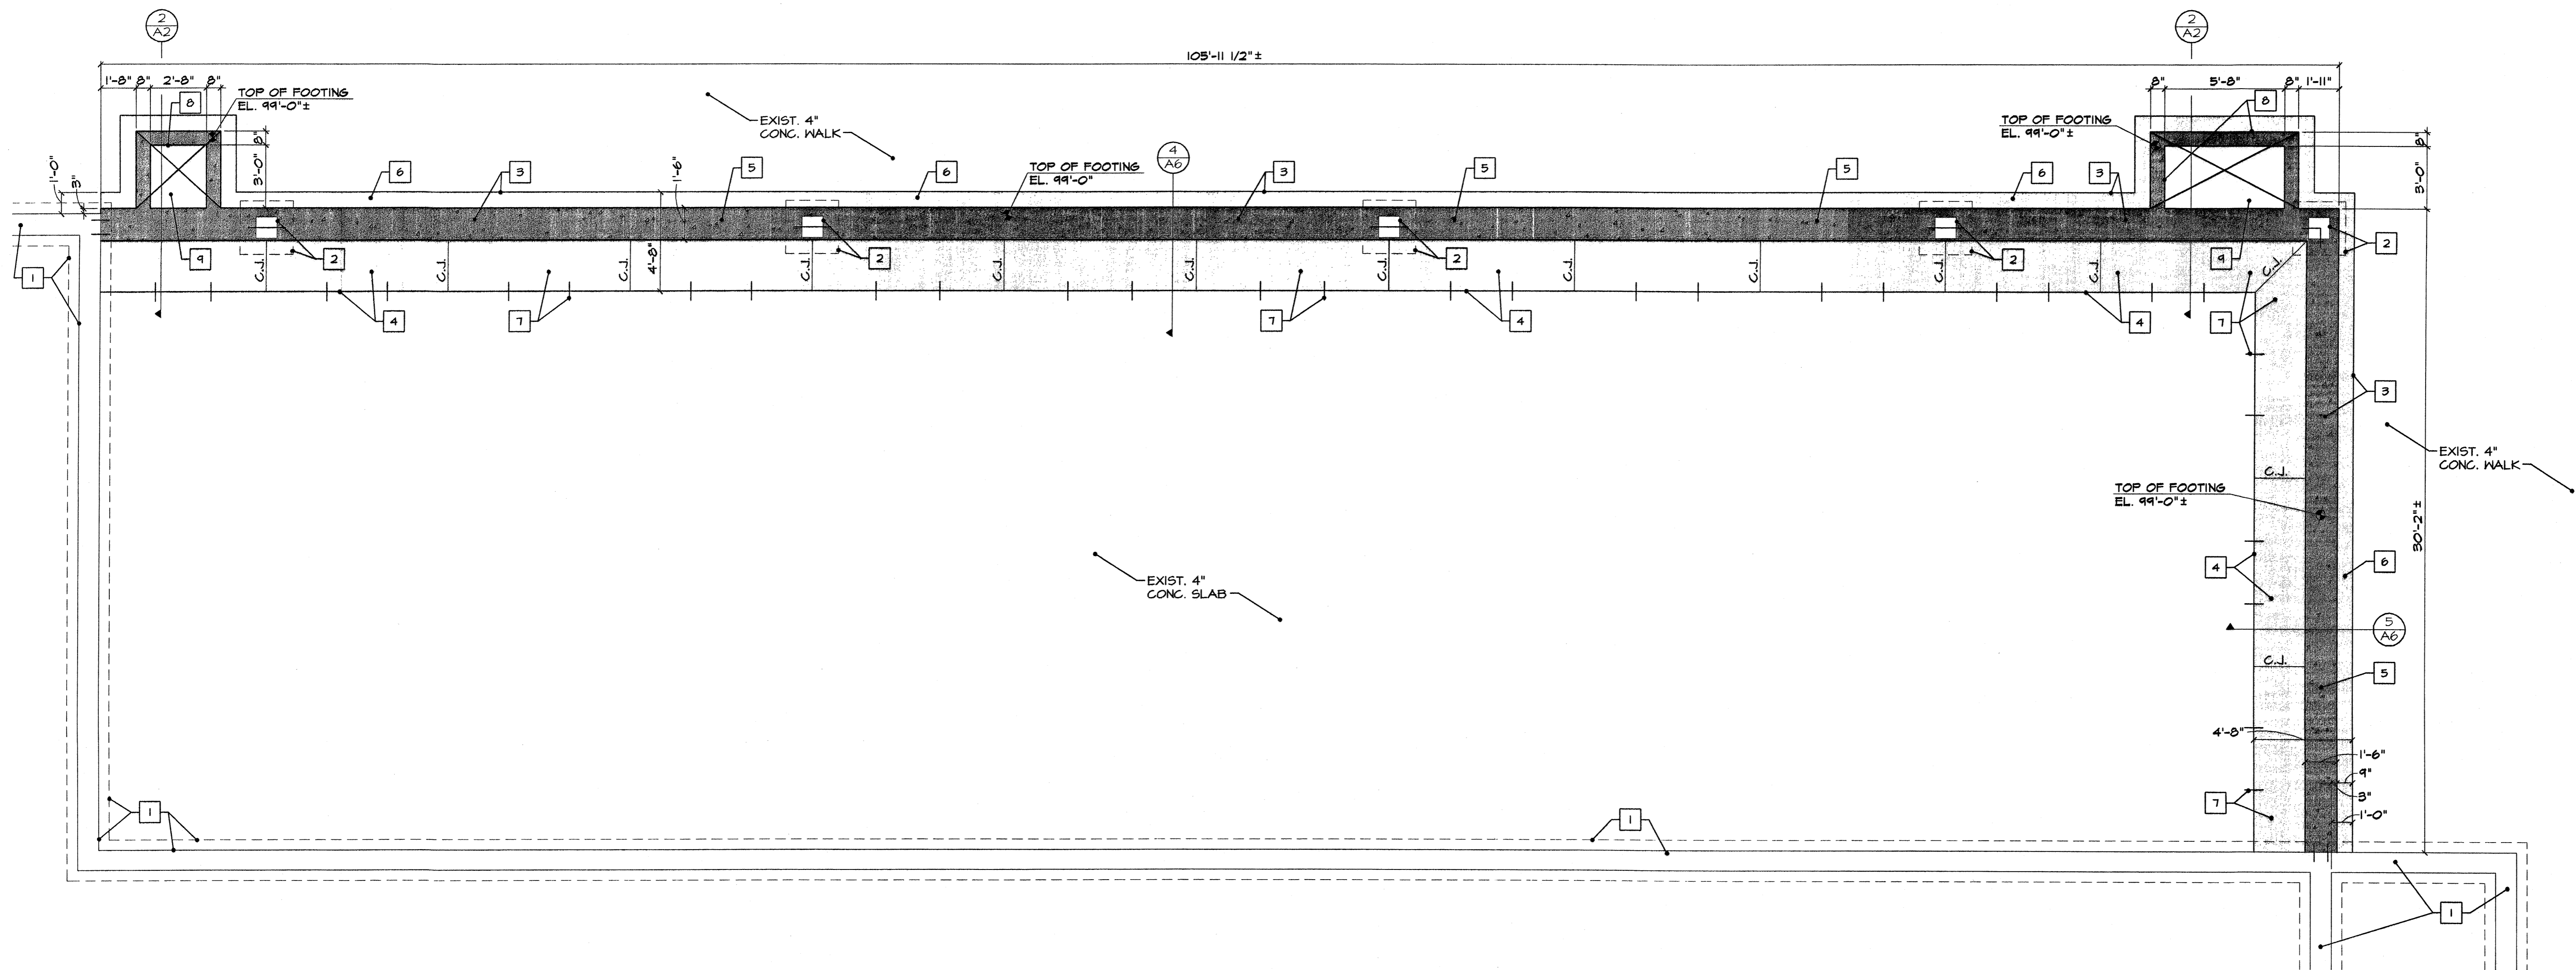

FOUNDATION PLAN
SCALE 1/4" = 1'-0"

PREPARED UNDER THE SUPERVISION OF:
PROJECT LOG
ISSUED FOR PLAN REVIEW
FILE: A2
PROJECT MGR: M.W.B.
DESIGNED BY: M.W.B.
DRAWN BY: M.J.K.
CHECKED BY: J.D.W.
SCALE: 1/4" = 1'-0"
SHEET: A2 of 6


OWNER:
CHARTER SCHOOL
ADMINISTRATION SERVICES
20755 GREENFIELD RD., SUITE 300
SOUTHFIELD, MICHIGAN 48075
(248) 788-4401

**MULTI-PURPOSE ROOM ADDITION
ACADEMY OF WARREN**
13843 E. EIGHT MILE RD.
WARREN, MICHIGAN 48089
FOUNDATION PLAN, MISC. DETAILS


Professional Services
AN ISO 9001
CERTIFIED COMPANY
www.wilcoxassociates.com
5859 SHERMAN ROAD • SHERMAN, MICHIGAN 48064
PHONE: (888) 752-5500
TOLL FREE: (888) 752-5500



A2

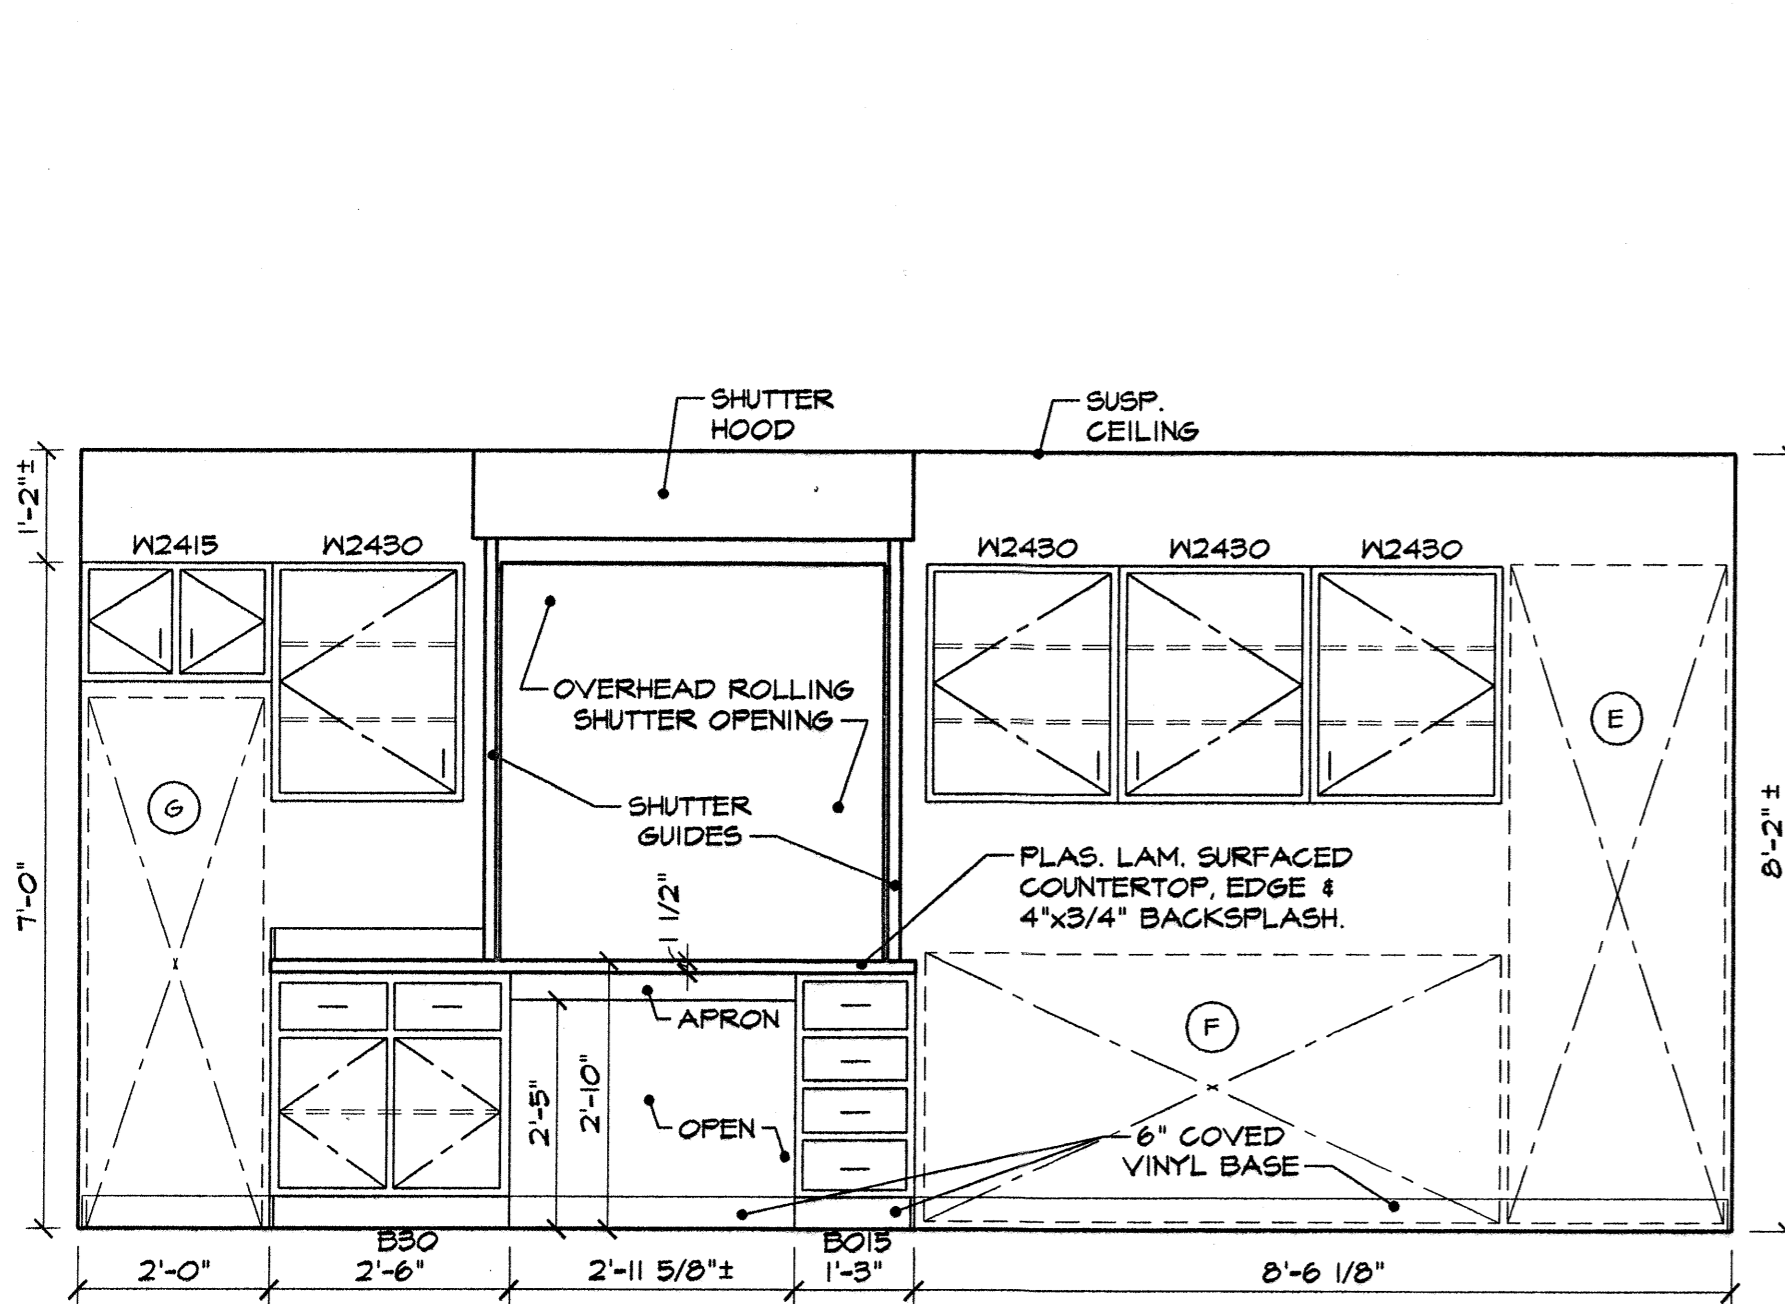

ELEVATION 'A'
SCALE: 3/4" = 1'-0"

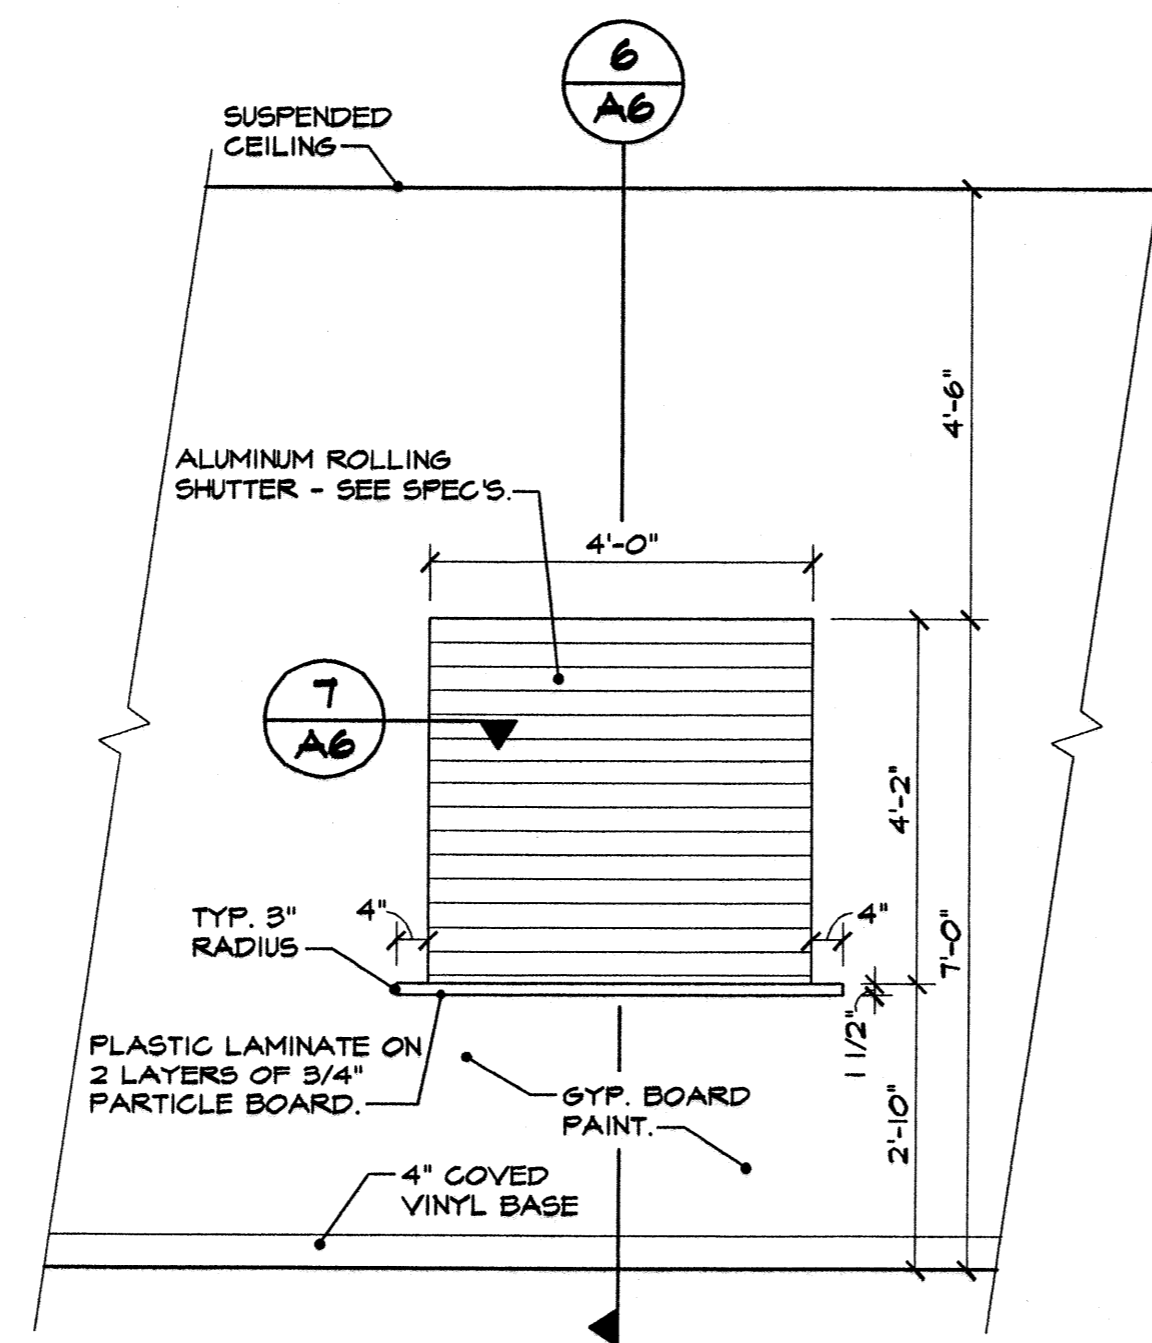


ELEVATION 'B'
SCALE: 1/2" = 1'-0"

KITCHEN EQUIPMENT LIST

- (A) 3-COMPARTMENT SINK - 1'-6 1/2"W. x 2'-0"D. x 3'-8 1/2"H.; TURBO-AIR MODEL No. T55-3-2D; STAINLESS STEEL WITH GALV. LEGS.
- (B) HAND SINK - 1'-5"W. x 1'-3"D. x 1'-2"H.; TURBO-AIR MODEL No. T55-1-H; STAINLESS STEEL WITH GOOSENECK FAUCET.
- (C) CONVECTION OVEN - 3'-2"W. x 3'-3 1/2"D. x 5'-0"H.; DUKE MODEL No. E101-6; NATURAL GAS.
- (D) FREEZER - 2'-3"W. x 2'-5 1/2"D. x 6'11 1/4"H.; TURBO-AIR MODEL No. T-23F; STAINLESS STEEL; 1/2 H.P. COMPRESSOR; 120/208V, 1 PHASE.
- (E) COOLER - 2'-3"W. x 2'-5"D. x 6'-11 1/4"H.; TURBO-AIR MODEL No. T-23; STAINLESS STEEL; 1/3 H.P. COMPRESSOR; 120/208V, 1 PHASE.
- (F) HOT FOOD UNIT - 6'-0 3/8"W. x 1'-10 1/2"D. x 2'-10"H.; AEROHOT MODEL No. E305/EP305; STAINLESS STEEL; 120/208V, 1 PHASE.
- (G) TURBO-AIR STAINLESS STEEL FOOD CART - 1'-10"W. x 2'-2"D. x 5'-7"H.

CONSTRUCTION NOTES

- 1 EXISTING ALUMINUM FRAMES & GLASS - NO CHANGE.
- 2 EXISTING DOOR & FRAME - NO CHANGE.
- 3 EXISTING ROWLOCK BRICK SILL - NO CHANGE.
- 4 EXISTING FACE BRICK WALL - NO CHANGE.
- 5 EXISTING BLOCK WALL - PAINT.
- 6 EXISTING EXTERIOR CONCRETE 'PATIO' SLAB - NO CHANGE.
- 7 EXISTING CONCRETE FLOOR SLAB - NO CHANGE.
- 8 EXISTING ROOF ABOVE - NO CHANGE.
- 9 EXISTING 4"x4" STEEL TUBE COLUMN - PAINT INTERIOR TO MATCH ALUMINUM FRAME COLOR.
- 10 EXISTING ELECTRICAL PANEL - SEE ELECTRICAL DRAWINGS.
- 11 NEW ALUMINUM FRAMES (MATCH EXISTING) WITH 1" INSULATED GLASS.
- 12 EXISTING STEEL CHANNEL LINTEL & BLOCK WALL ABOVE - PAINT.
- 13 NEW 3/4" CULTURED MARBLE SILL ON NEW 8" BLOCK MASONRY WALL BELOW - PAINT.
- 14 NEW SLOPED ROWLOCK BRICK SILL ON NEW FACE BRICK MASONRY WALL BELOW (MATCH EXISTING).
- 15 NEW 4 1/2"x4 1/2" ALUMINUM TUBE SECTION TO MATCH EXISTING.
- 16 NEW ALUMINUM THRESHOLD.
- 17 REMOVE EXISTING DOOR, FRAME, THRESHOLD & PORTION OF MASONRY WALL; INSTALL NEW LINTEL - (3) 5"x3 1/2"x5/16" (LL.V.) STEEL ANGLES OR MBX10 BEAM WITH 11"x3/8" BOTTOM PLATE - BOTTOM OF NEW LINTEL EL. 104'-0".
- 18 INSTALL NEW 5/8" GYPSUM BOARD ON 7/8" METAL FURRING CHANNELS.
- 19 NEW DOOR & FRAME - SEE DOOR SCHEDULE.
- 20 NEW 3 5/8"x20 GA. STEEL STUDS AT 16" O.C. WITH 5/8" GYPSUM BOARD EACH SIDE (WALL HEIGHT 12'-0").
- 21 PLASTIC LAMINATE SURFACED COUNTERTOP & BACKSPLASH WITH BASE CABINETS BELOW - SEE ELEVATION 'A'.
- 22 OVERHEAD ROLLING SHUTTER - SEE ELEVATION 'B'.
- 23 ALIGN OUTSIDE FACE OF NEW BRICK WITH FACE OF EXISTING WALL.

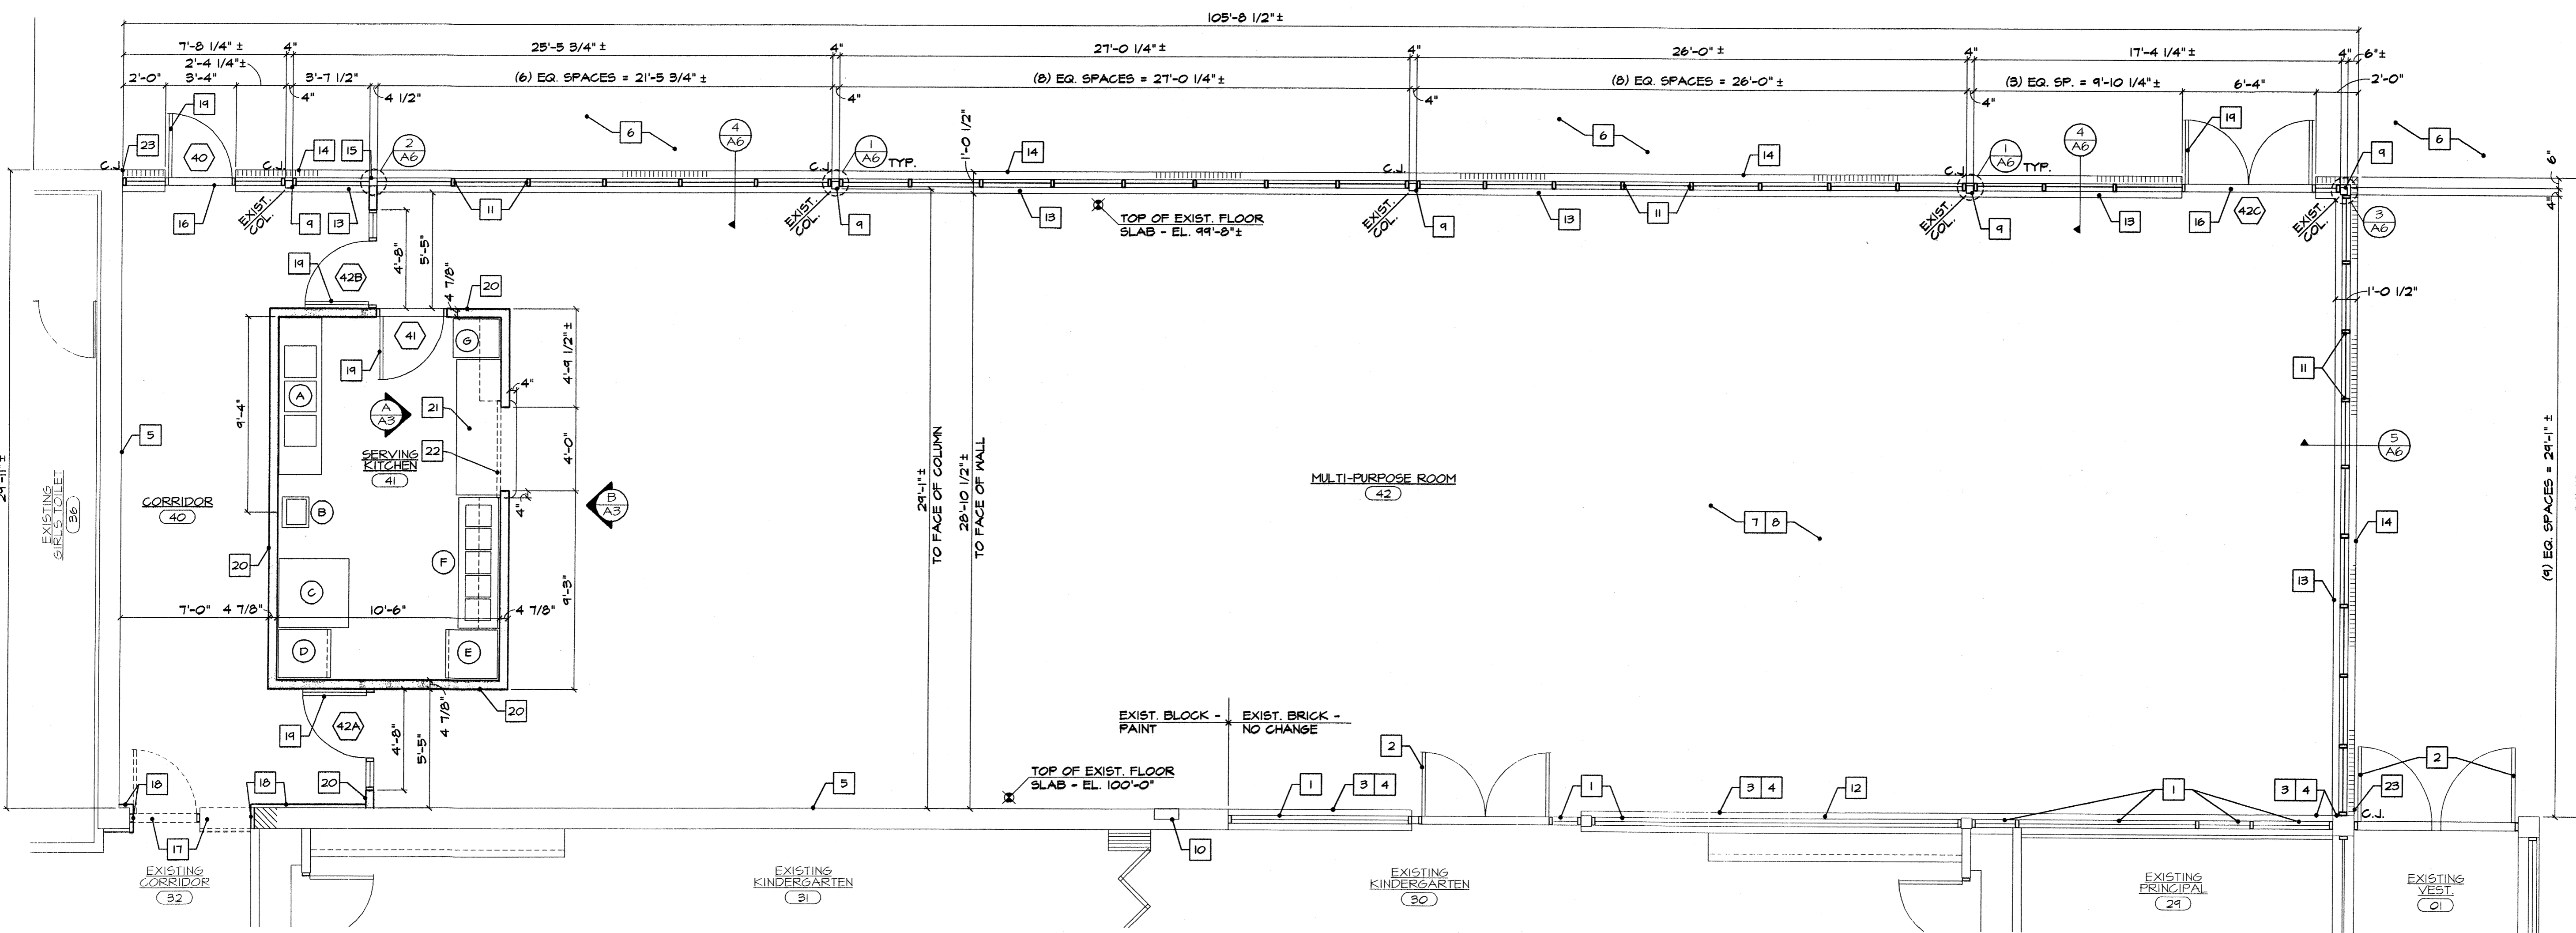

FLOOR PLAN
SCALE: 1/4" = 1'-0"

PREPARED UNDER THE SUPERVISION OF:

PROJECT LOG	15-10-23
DESIGNED FOR PLAN REVIEW	

FILE: A3	
PROJECT MGR. M.W.B.	
DESIGNED BY: M.W.B.	
DRAWN BY: M.J.K.	
CHECKED BY: J.D.W.	
SCALE: AS NOTED	
SHEET: A3 of 6	

OWNER:
MULTI-PURPOSE ROOM ADDITION
ACADEMY OF WARREN
13943 E. EIGHT MILE RD.
WARREN, MICHIGAN 48089


Professional Services
AN ISO 9001 CERTIFIED COMPANY
WWW.WILCOXPROF.SERVICES.COM
5500 WILCOX RD. # 5000 WARREN, MICHIGAN 48094
PHONE: (586) 752-5500 FAX: (586) 752-5550

WILCOX

FLOOR PLAN, INTERIOR ELEVATIONS

CHARTER SCHOOL ADMINISTRATION SERVICES
20755 GREENFIELD RD., SUITE 300
SOUTHFIELD, MICHIGAN 48076
(248) 788-4401

A3

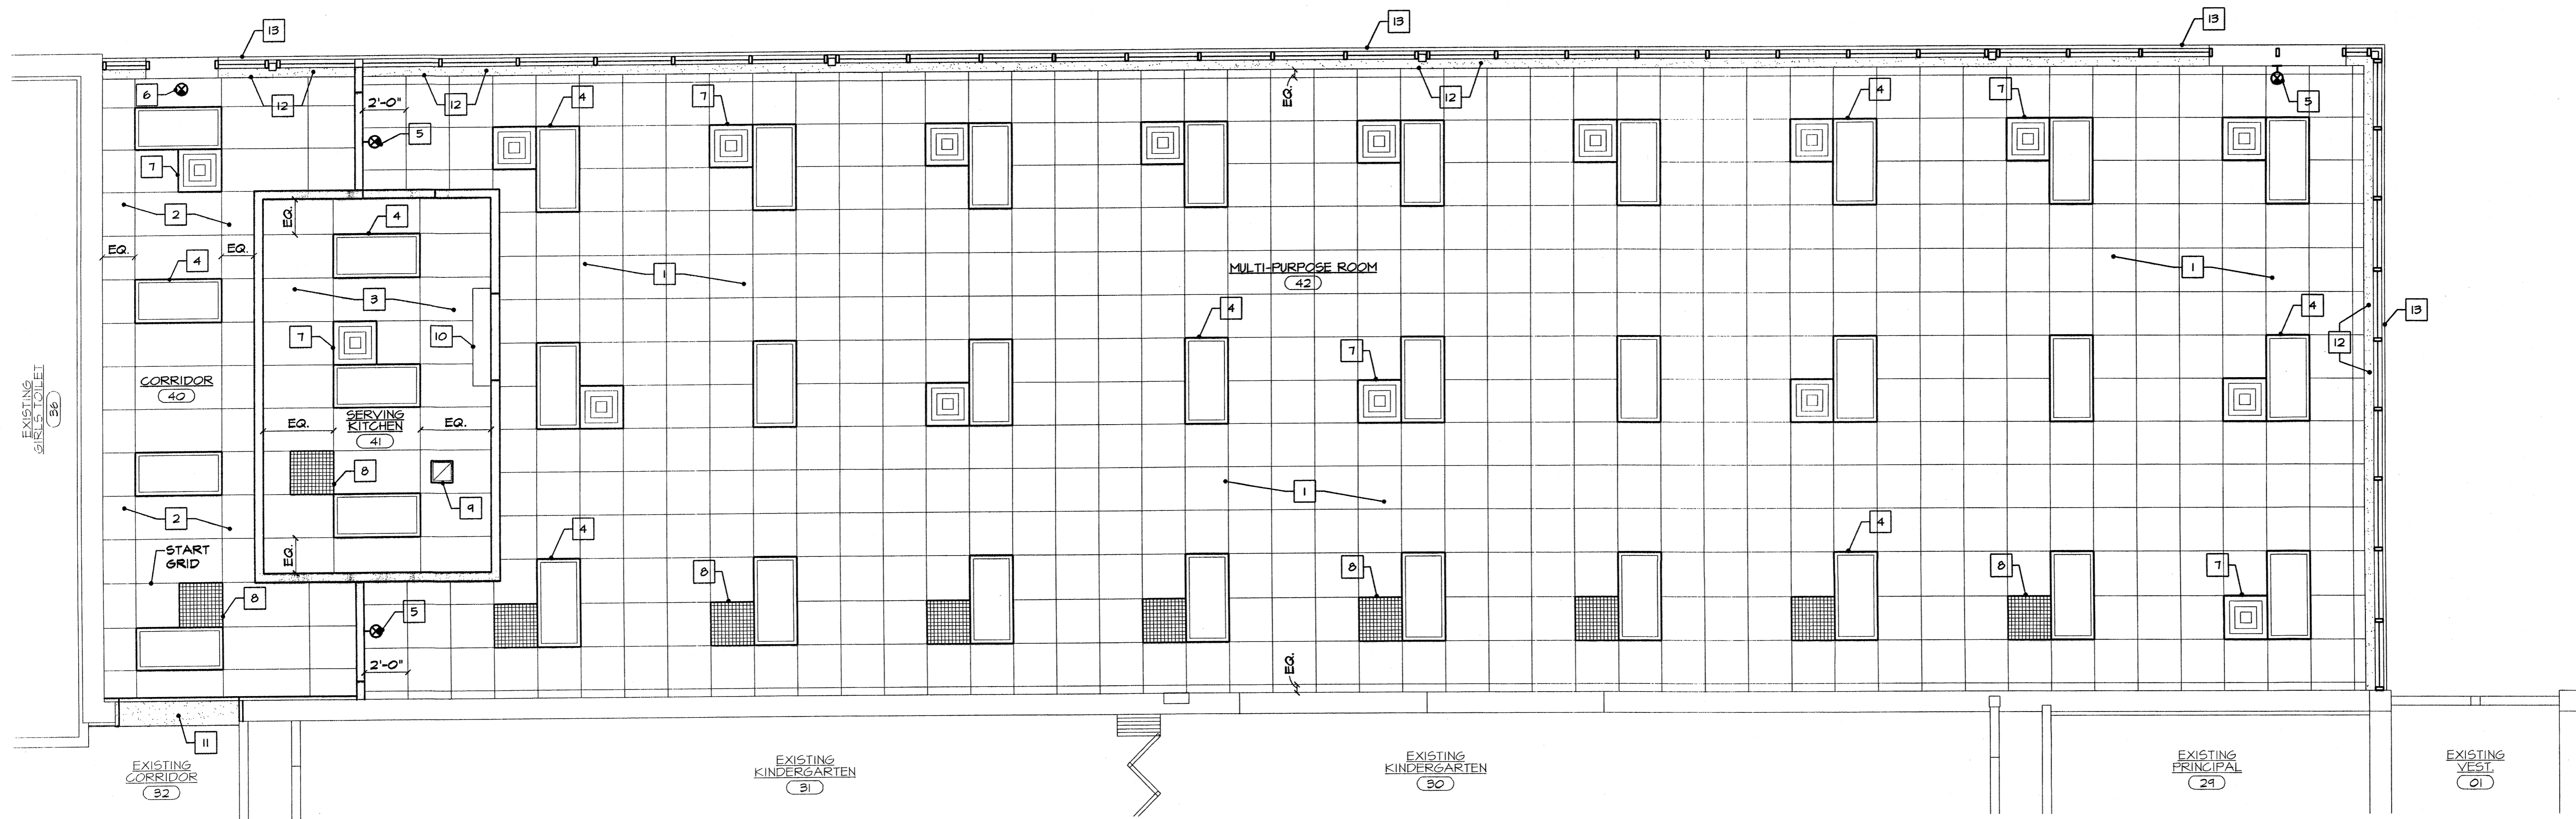

CONSTRUCTION NOTES

- 1 2'x2' SUSPENDED ACOUSTICAL TILE CEILING @ 11'-6" A.F.F.
- 2 2'x4' SUSPENDED ACOUSTICAL TILE CEILING @ 9'-0" A.F.F.
- 3 2'x4' SUSPENDED VINYL - FACE GYPSUM BOARD CEILING PANELS @ 8'-2" A.F.F.
- 4 2'x4' RECESSED FLUORESCENT LIGHT FIXTURE - SEE ELECTRICAL.
- 5 WALL MOUNTED LIGHTED EXIT SIGN - SEE ELECTRICAL.
- 6 CEILING MOUNTED LIGHTED EXIT SIGN - SEE ELECTRICAL.
- 7 SUPPLY AIR DIFFUSER - SEE MECHANICAL.
- 8 RETURN AIR GRILL - SEE MECHANICAL.
- 9 EXHAUST FAN GRILL - SEE MECHANICAL.
- 10 ALUMINUM ROLLING SHUTTER HOOD - SEE ARCHITECTURAL.
- 11 GYPSUM BOARD BULKHEAD @ 8'-10" A.F.F. - PAINT.
- 12 INSTALL 5/8" GYPSUM BOARD OVER FACE OF EXISTING BULKHEAD AND RETURN TO ALUMINUM WINDOW FRAME WITH CASING BEAD - PAINT AND CAULK.
- 13 INSTALL WOOD TRIM TO MATCH EXISTING AT BOTTOM OF BULKHEAD TO 1/4" FROM ALUMINUM WINDOW FRAME - PAINT AND CAULK.

PREPARED UNDER THE SUPERVISION OF:

FILE: A4	PROJECT LOG
PROJECT MGR. M.W.B.	ISSUED FOR REVIEW
DESIGNED BY: M.W.B.	
DRAWN BY: M.J.K.	
CHECKED BY: J.D.W.	
SCALE: 1/4" = 1'-0"	
SHEET: A4 of 6	


OWNER:
CHARTER SCHOOL ADMINISTRATION SERVICES
 20755 GREENFIELD RD., SUITE 300
 SOUTHFIELD, MICHIGAN 48075
 (248) 769-4401

**MULTI-PURPOSE ROOM ADDITION
 ACADEMY OF WARREN**
 13943 E. EIGHT MILE RD.
 WARREN, MICHIGAN 48089
REFLECTED CEILING PLAN

Wilcox Professional Services
 AN ISO 9001 CERTIFIED COMPANY
 WWW.WILCOXPROFESIONALSERVICES.COM
 5809 SHERMAN ROAD • SACRAMENTO, MICHIGAN 48064
 PHONE (989) 732-5500 • FAX (989) 732-8600
 TOLL FREE (888) 732-5500

REFLECTED CEILING PLAN
 SCALE 1/4" = 1'-0"


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EAST ELEVATION
SCALE 1/4" = 1'-0"

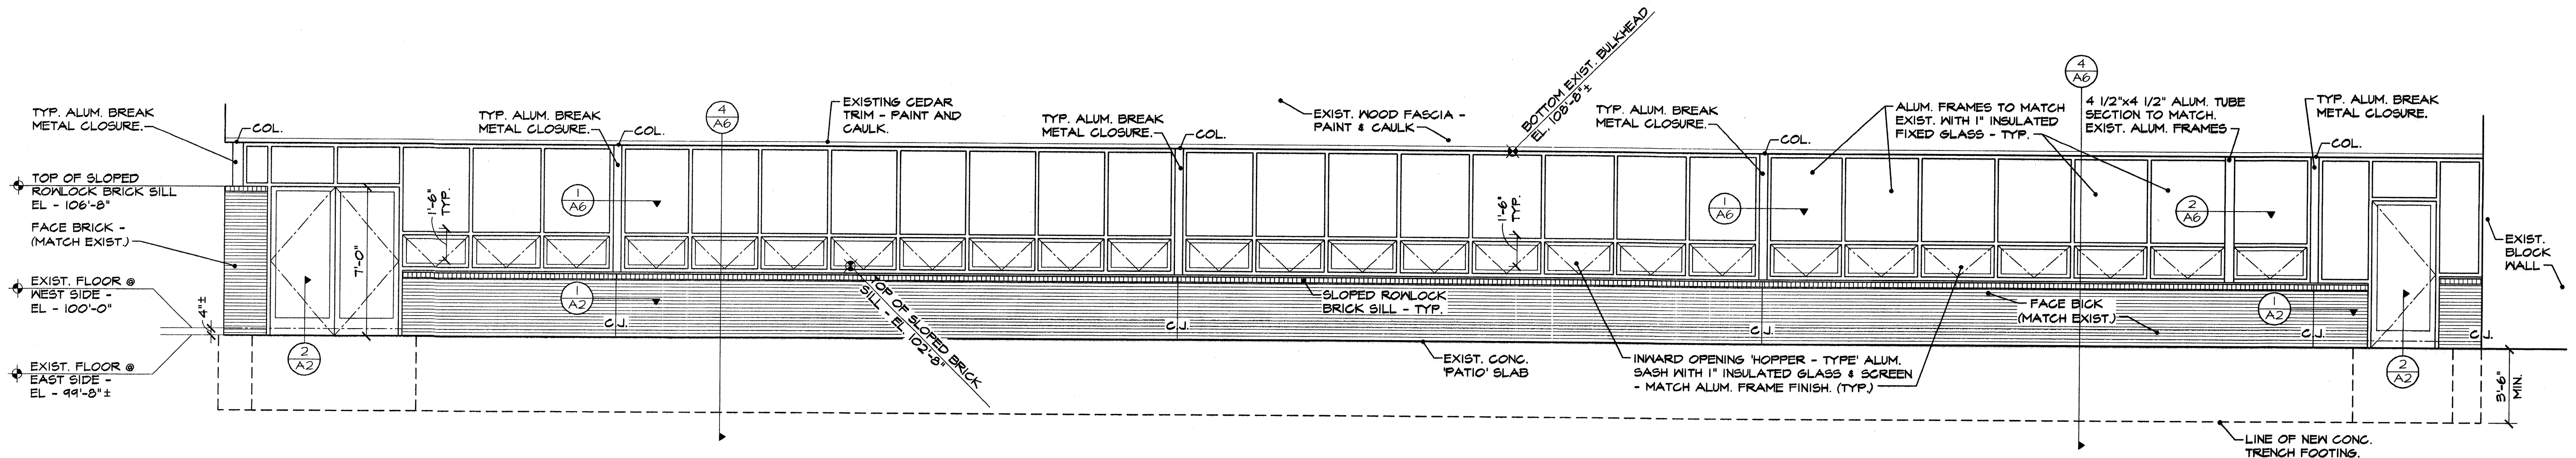TOTAL AREA OF OPERABLE SASH - PERCENT OF GROSS FLOOR AREA - %


NEW CONCRETE BLOCK MASONRY UNIT AND NEW BASE BRICK COURSING SHALL ALIGN WITH EXISTING MASONRY COURSING.




SOUTH ELEVATION
SCALE 1/4" = 1'-0"

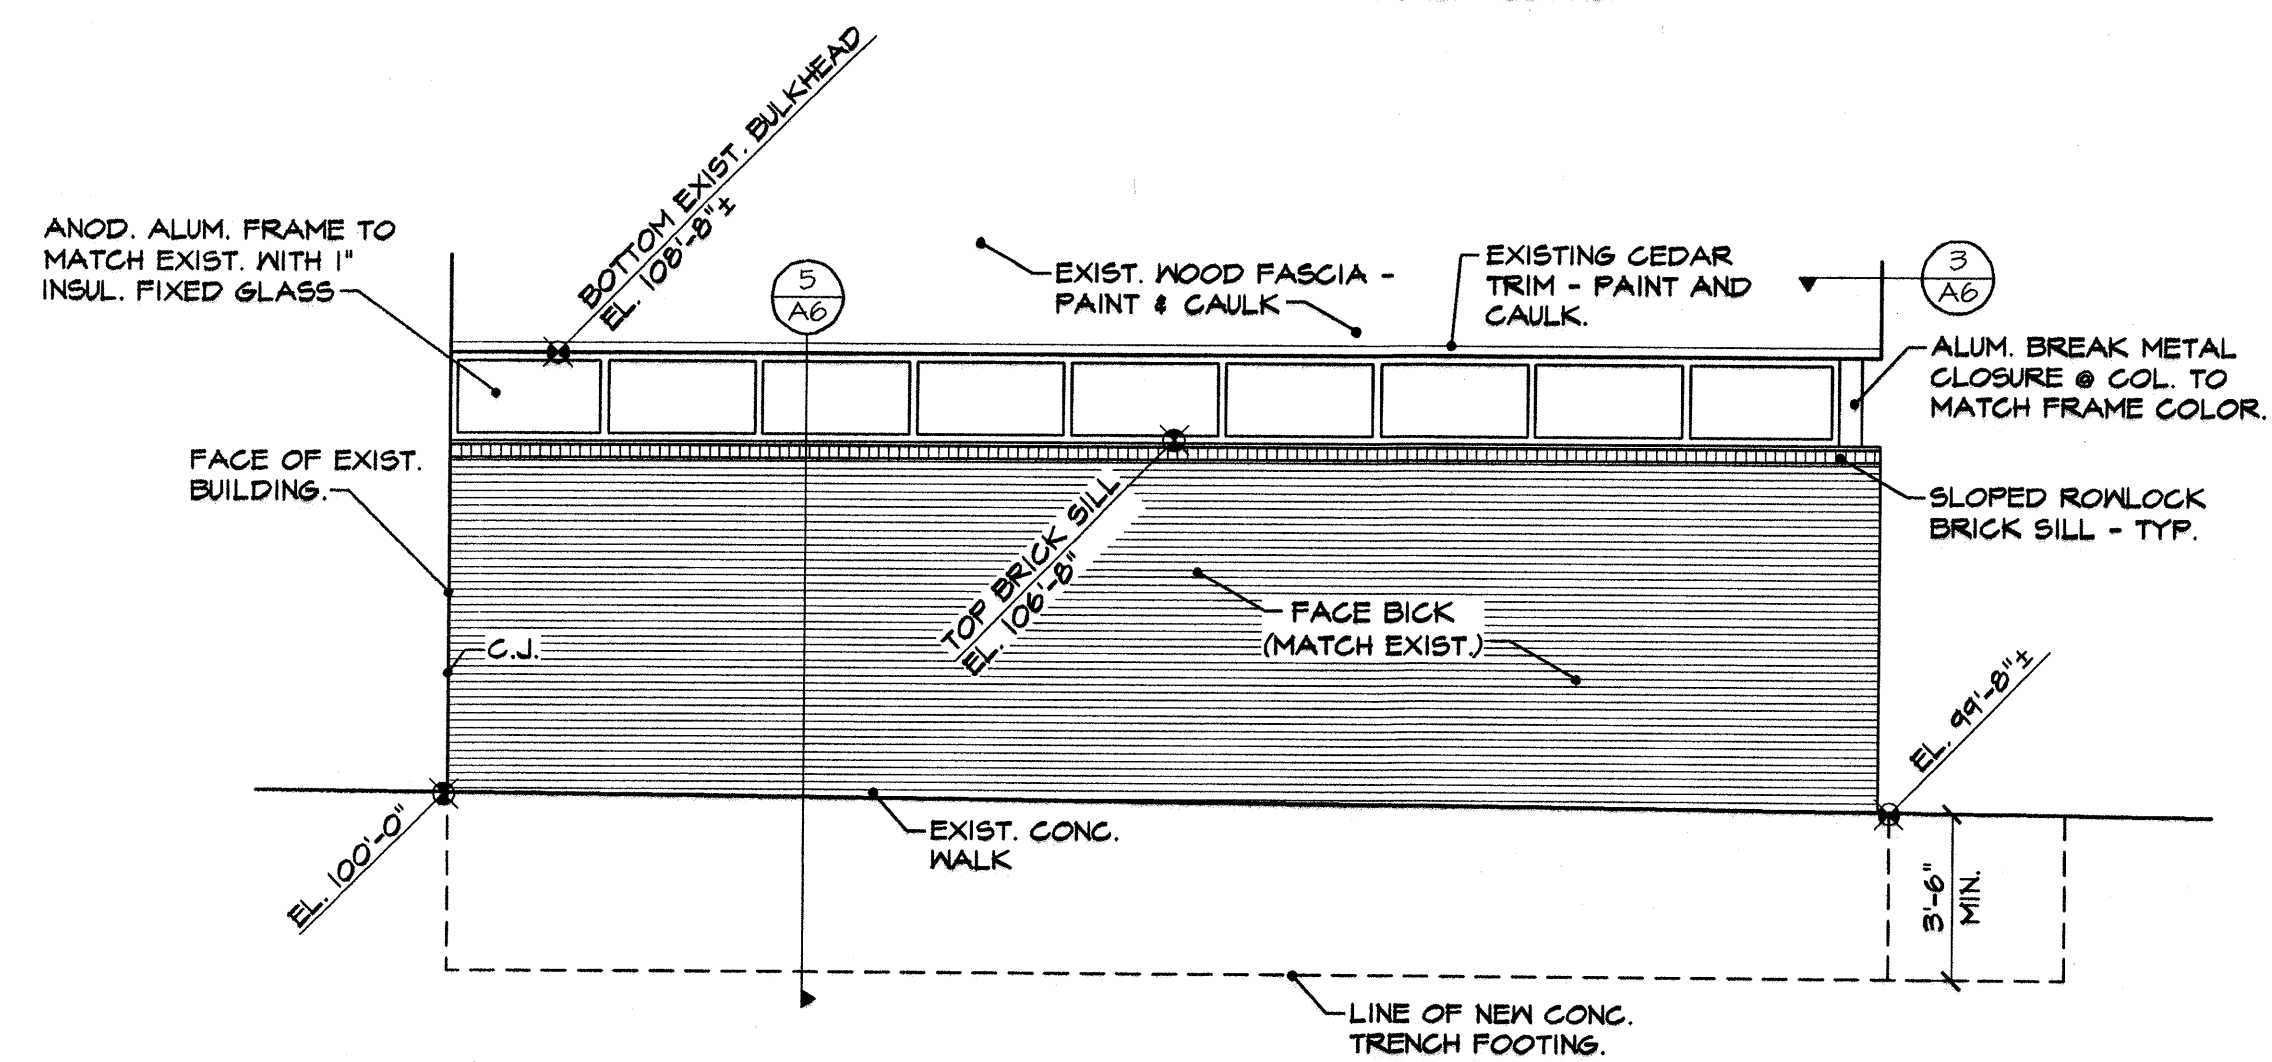DOOR & FRAME SCHEDULE									
No.	SIZE	DOOR			FRAME			NOTES	
		MATERIAL	FINISH	TYPE	MATERIAL	FINISH	TYPE		
	3'-0" x 6'-8" x 1 3/4" (2) 3'-0" x 7'-0" x 1 3/4" 3'-0" x 7'-0" x 1 3/4"	ALUMINUM & GLASS BIRCH - SOLID CORE	PREFINISHED		ALUMINUM HOLLOW METAL	PREFINISHED PAINT		MATCH EXISTING DOOR HARDWARE.	
40							3	ALUM. THRESHOLD	
41							1		
42A							2		
42B							2		
42C							4	ALUM. THRESHOLD	

ROOM FINISH SCHEDULE							
No.	NAME	FLOOR	BASE	WALLS	CEILING	HT.	NOTES
41	SERVING KITCHEN					8'-2"	PREFIN. VINYL. FACED CEILING PANELS
42	MULTI-PURPOSE ROOM					11'-6"	

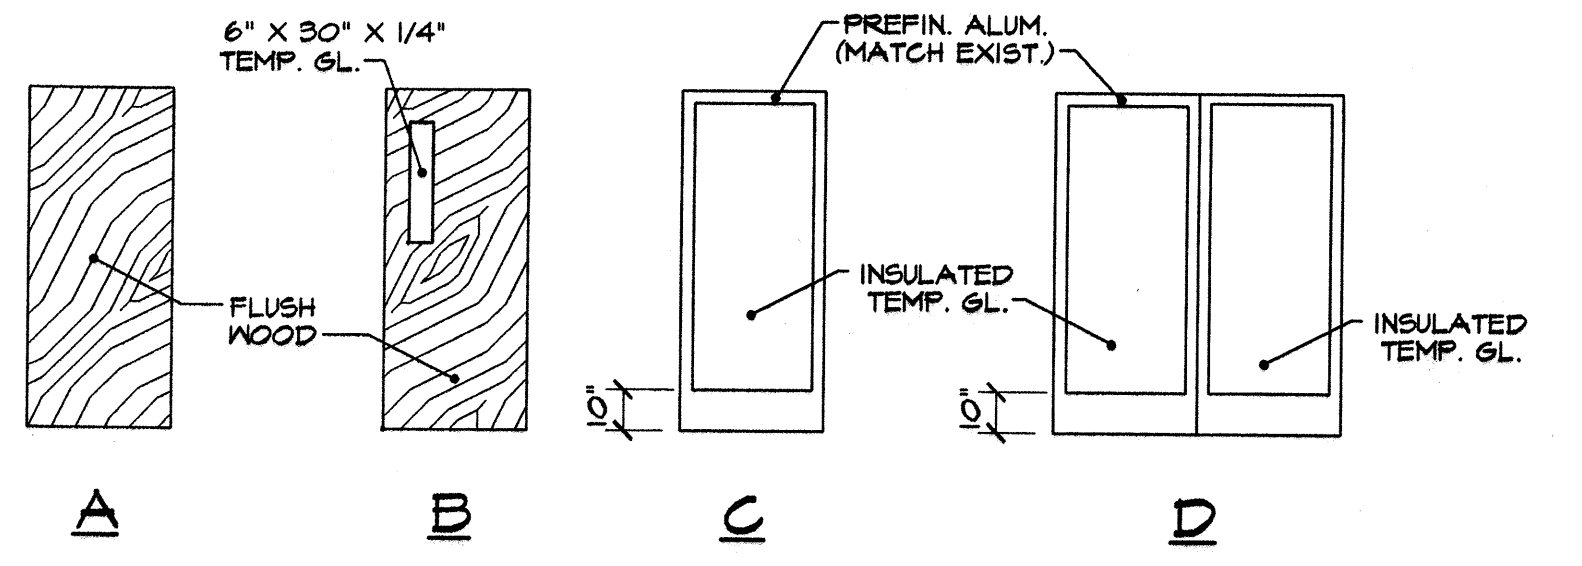

DOOR TYPES
NO SCALE

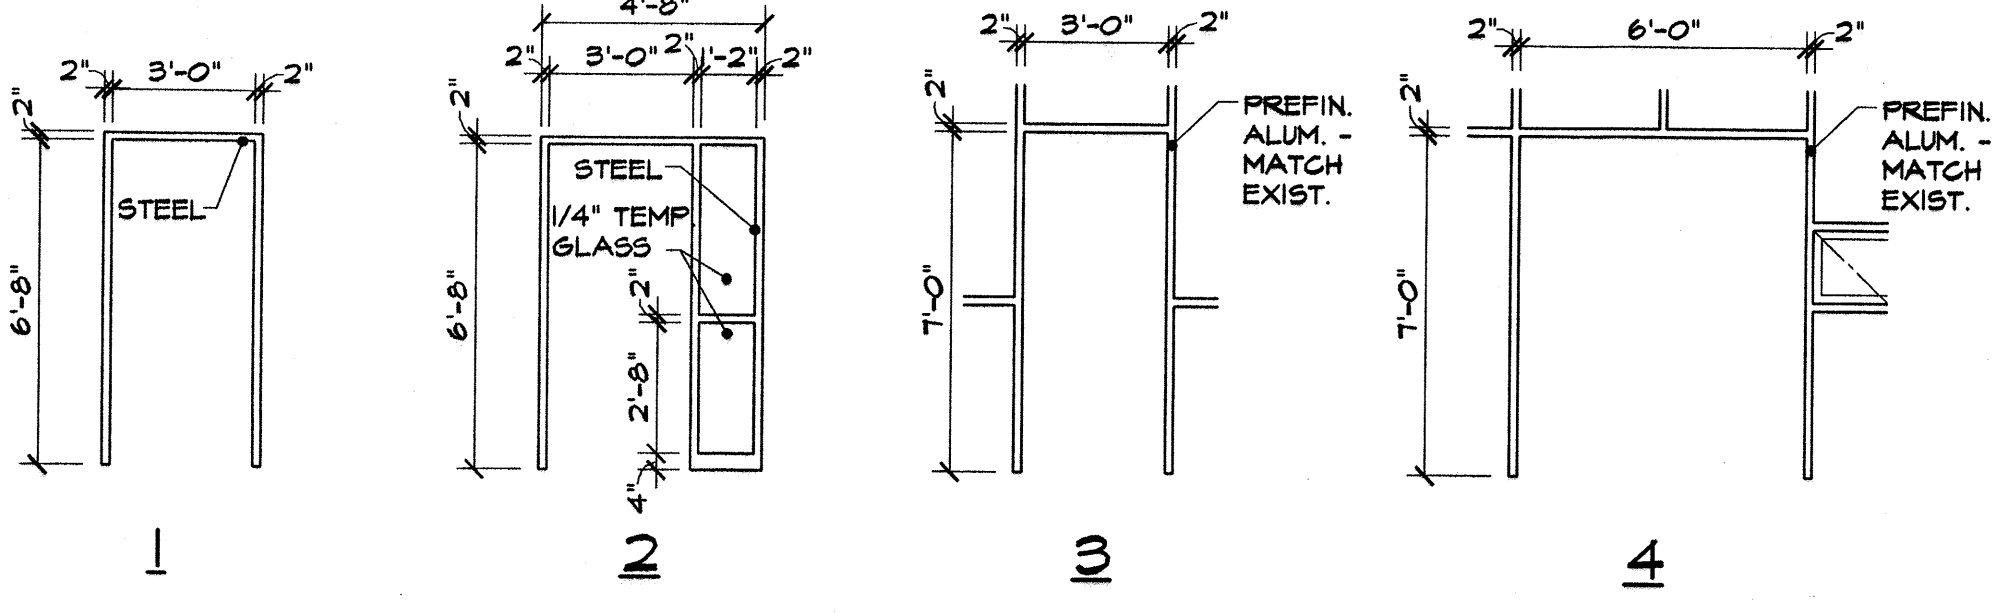

FRAME TYPES
NO SCALE

PREPARED UNDER THE SUPERVISION OF:
 PROJECT LOG
 FILE: A1
 PROJECT NO.: M.W.B.
 DESIGNED BY: M.W.B.
 DRAWN BY: M.J.K.
 CHECKED BY: J.D.W.
 SCALE: AS NOTED
 SHEET: **A5 of 6**


OWNER:
CHARTER SCHOOL ADMINISTRATION SERVICES
 20755 GREENFIELD RD., SUITE 300
 SOUTHFIELD, MICHIGAN 48075
 (248) 789-4401

MULTI-PURPOSE ROOM ADDITION ACADEMY OF WARREN
 18943 E EIGHT MILE RD.
 WARREN, MICHIGAN 48098


EXTERIOR ELEVATIONS/ ROOM FINISH AND DOOR SCHEDULES

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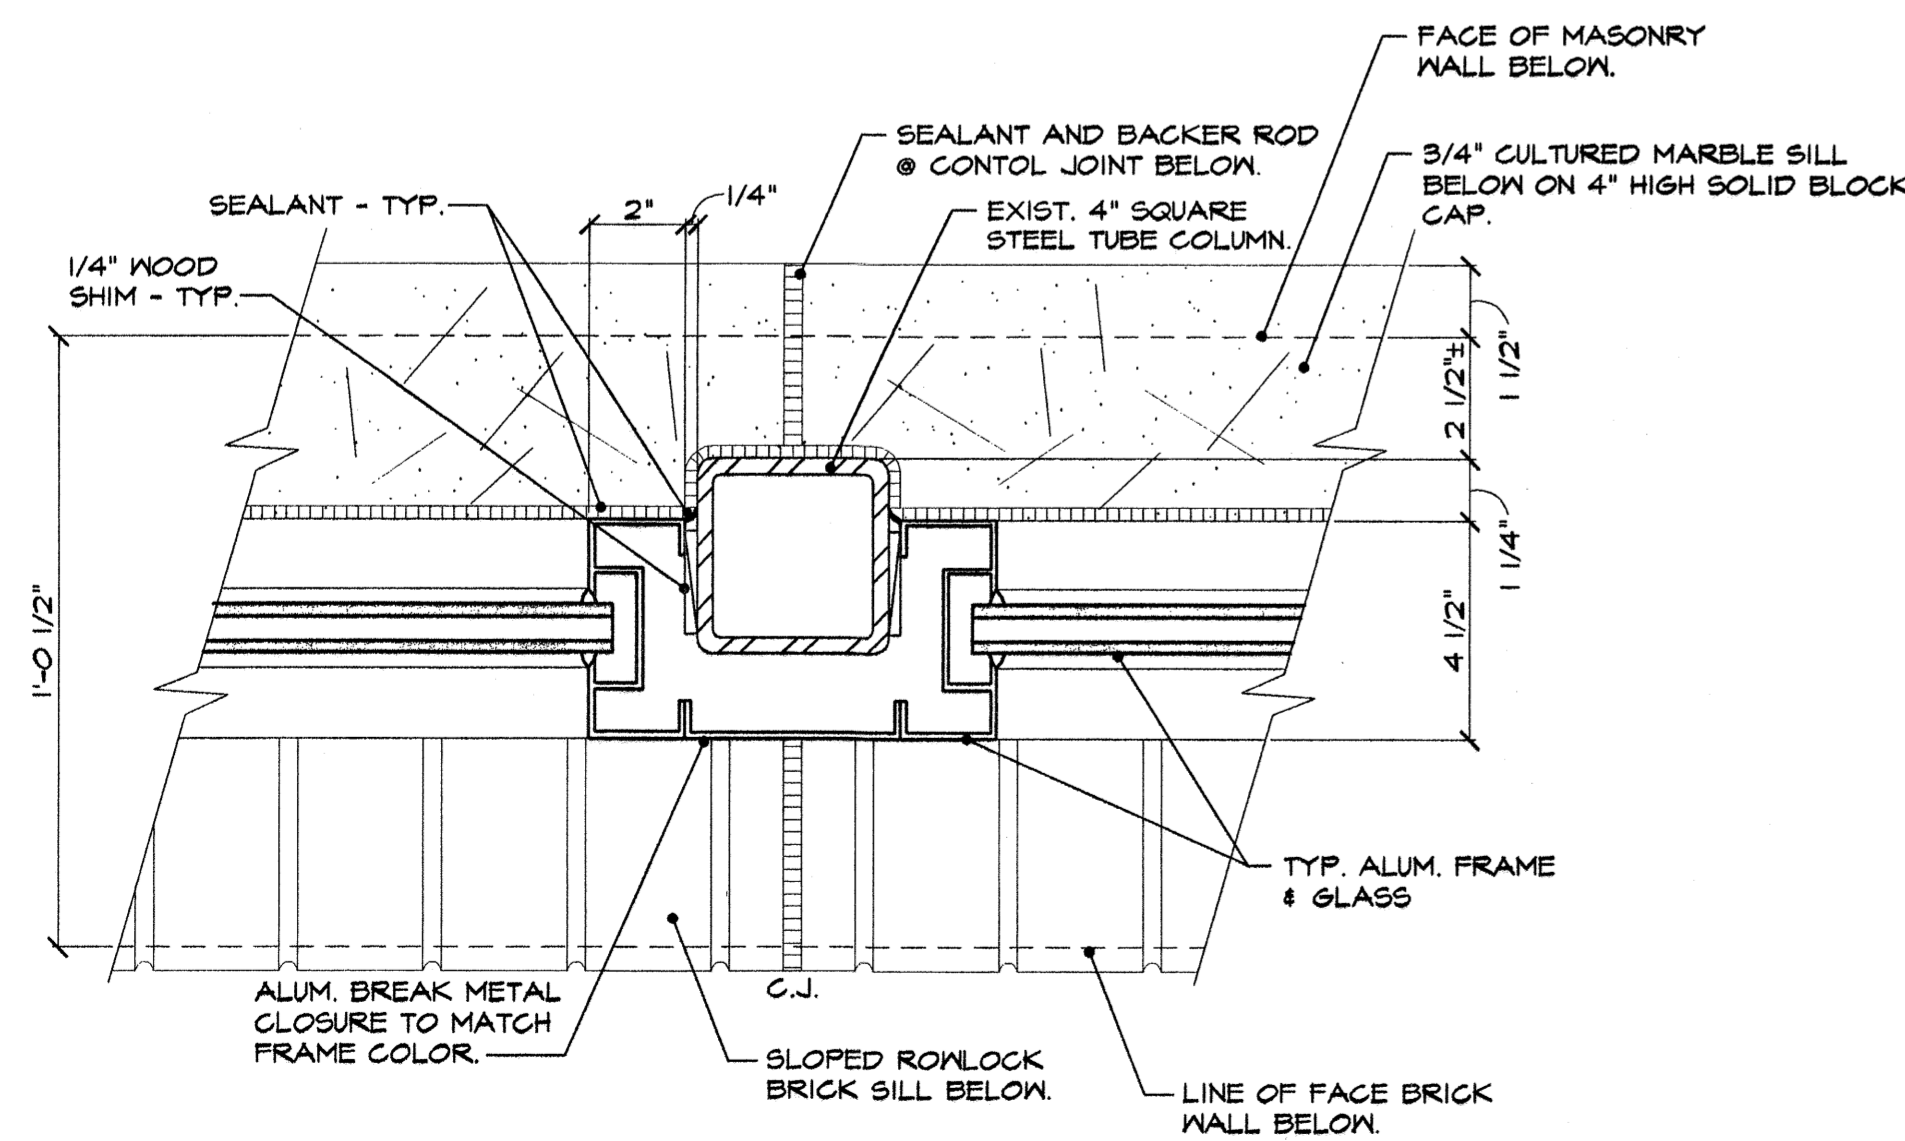
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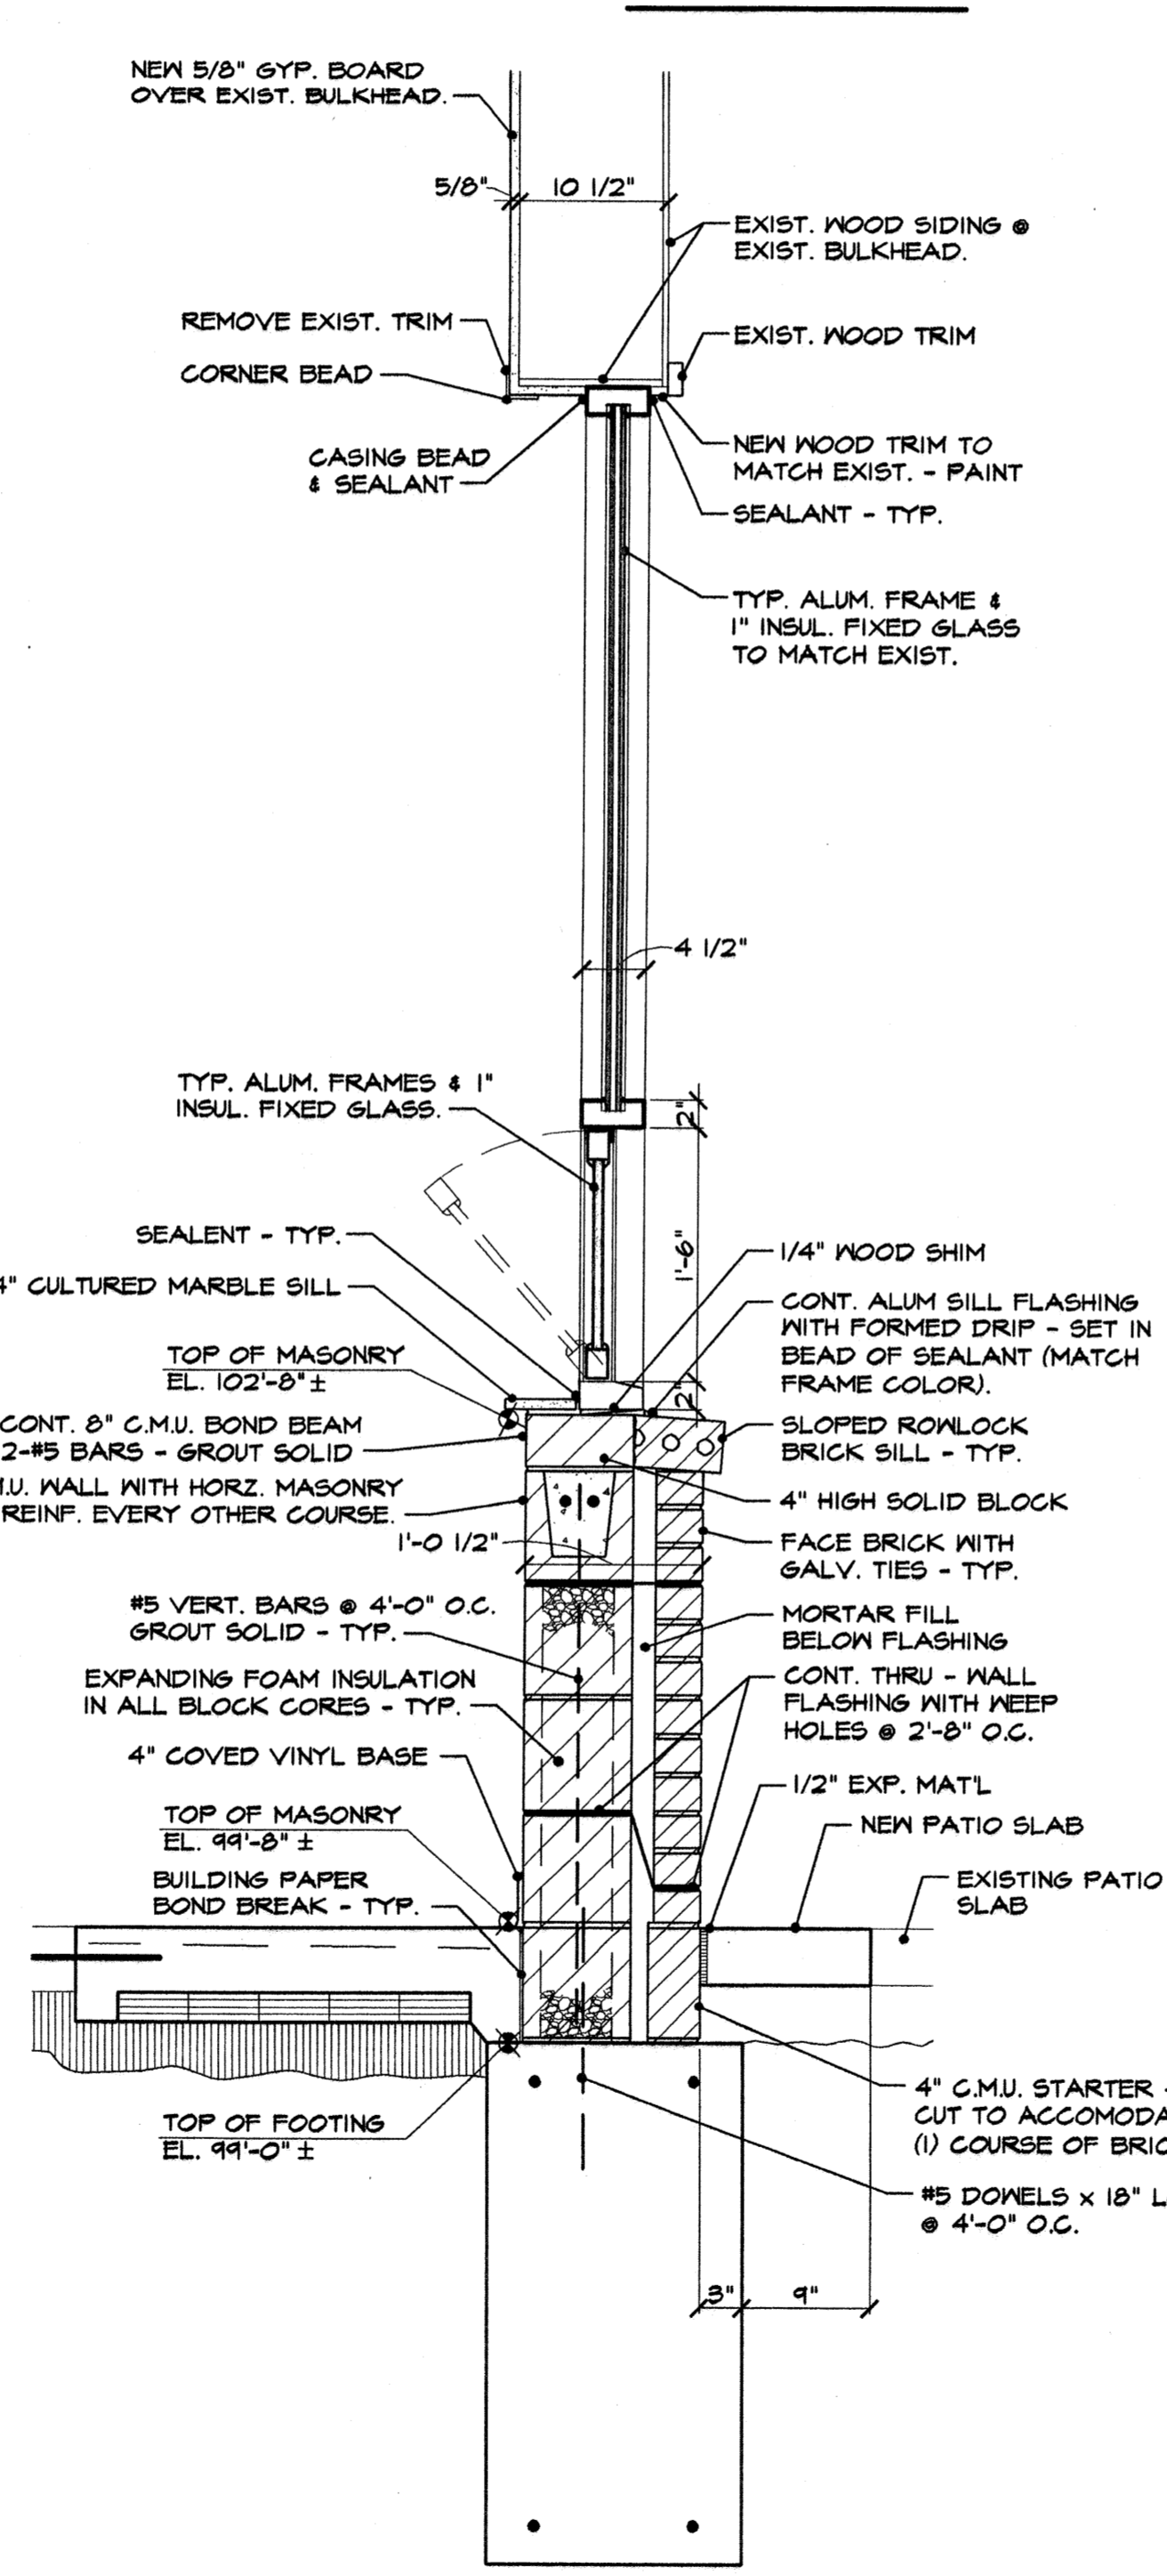
3 **DETAIL #3**
SCALE: 3" = 1'-0"

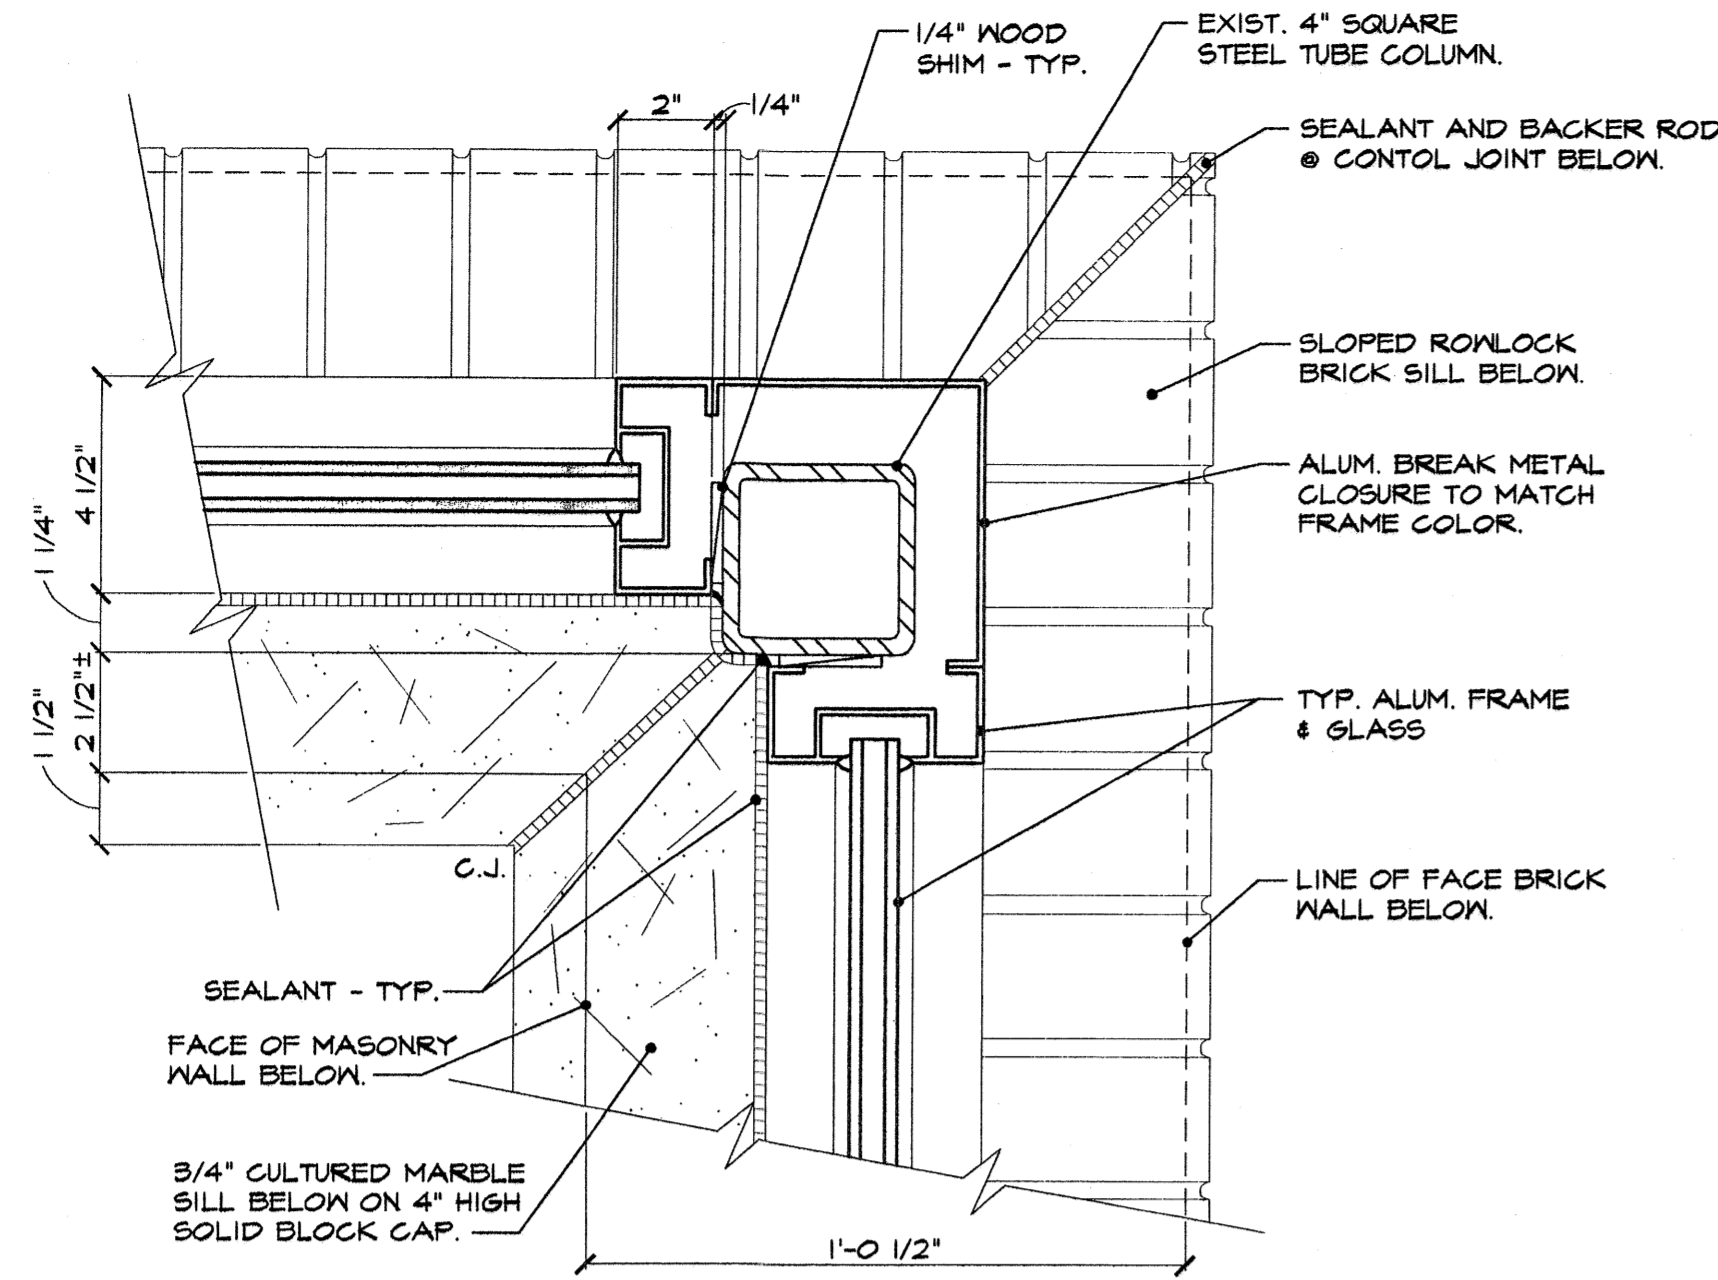


2 **DETAIL #2**
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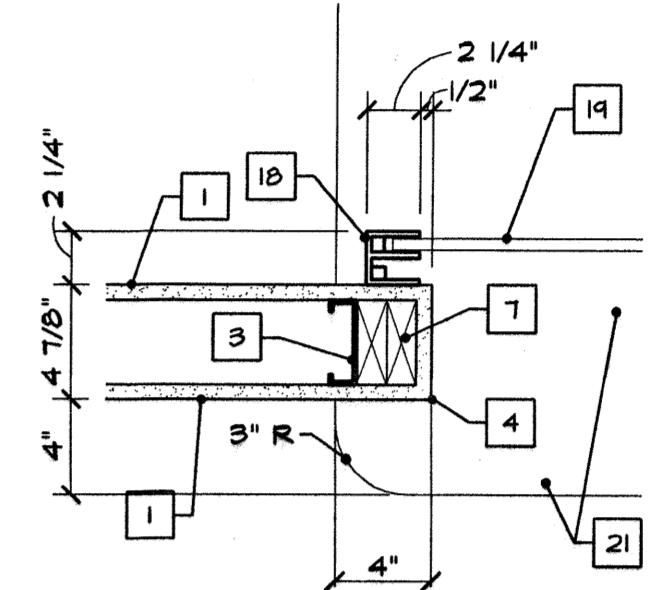
1 **TYP. EXIST. COLUMN SECTION**
SCALE: 3" = 1'-0"

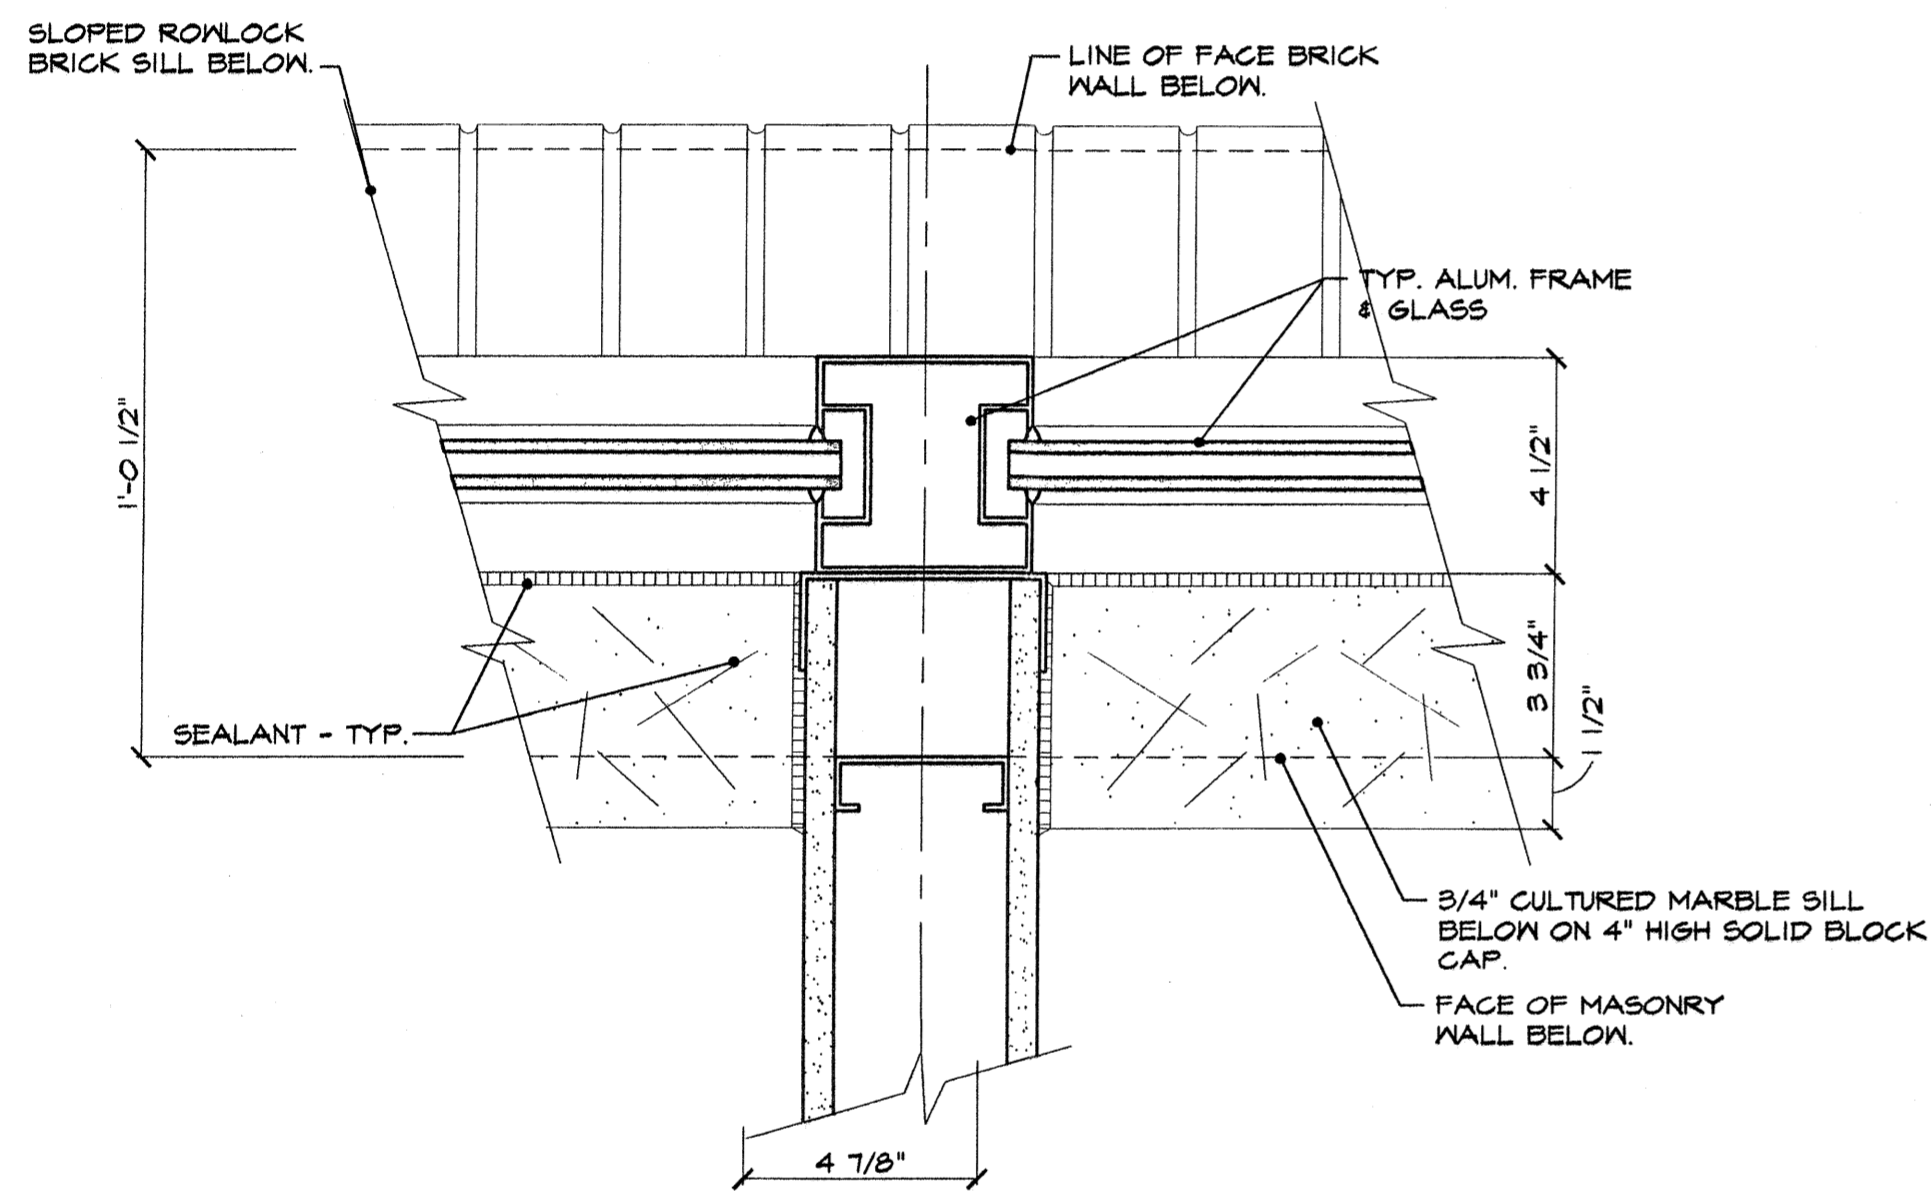


4 **WALL SECTION #4**
SCALE: 3" = 1'-0"




5 **WALL SECTION #5**
SCALE: 1" = 1'-0"

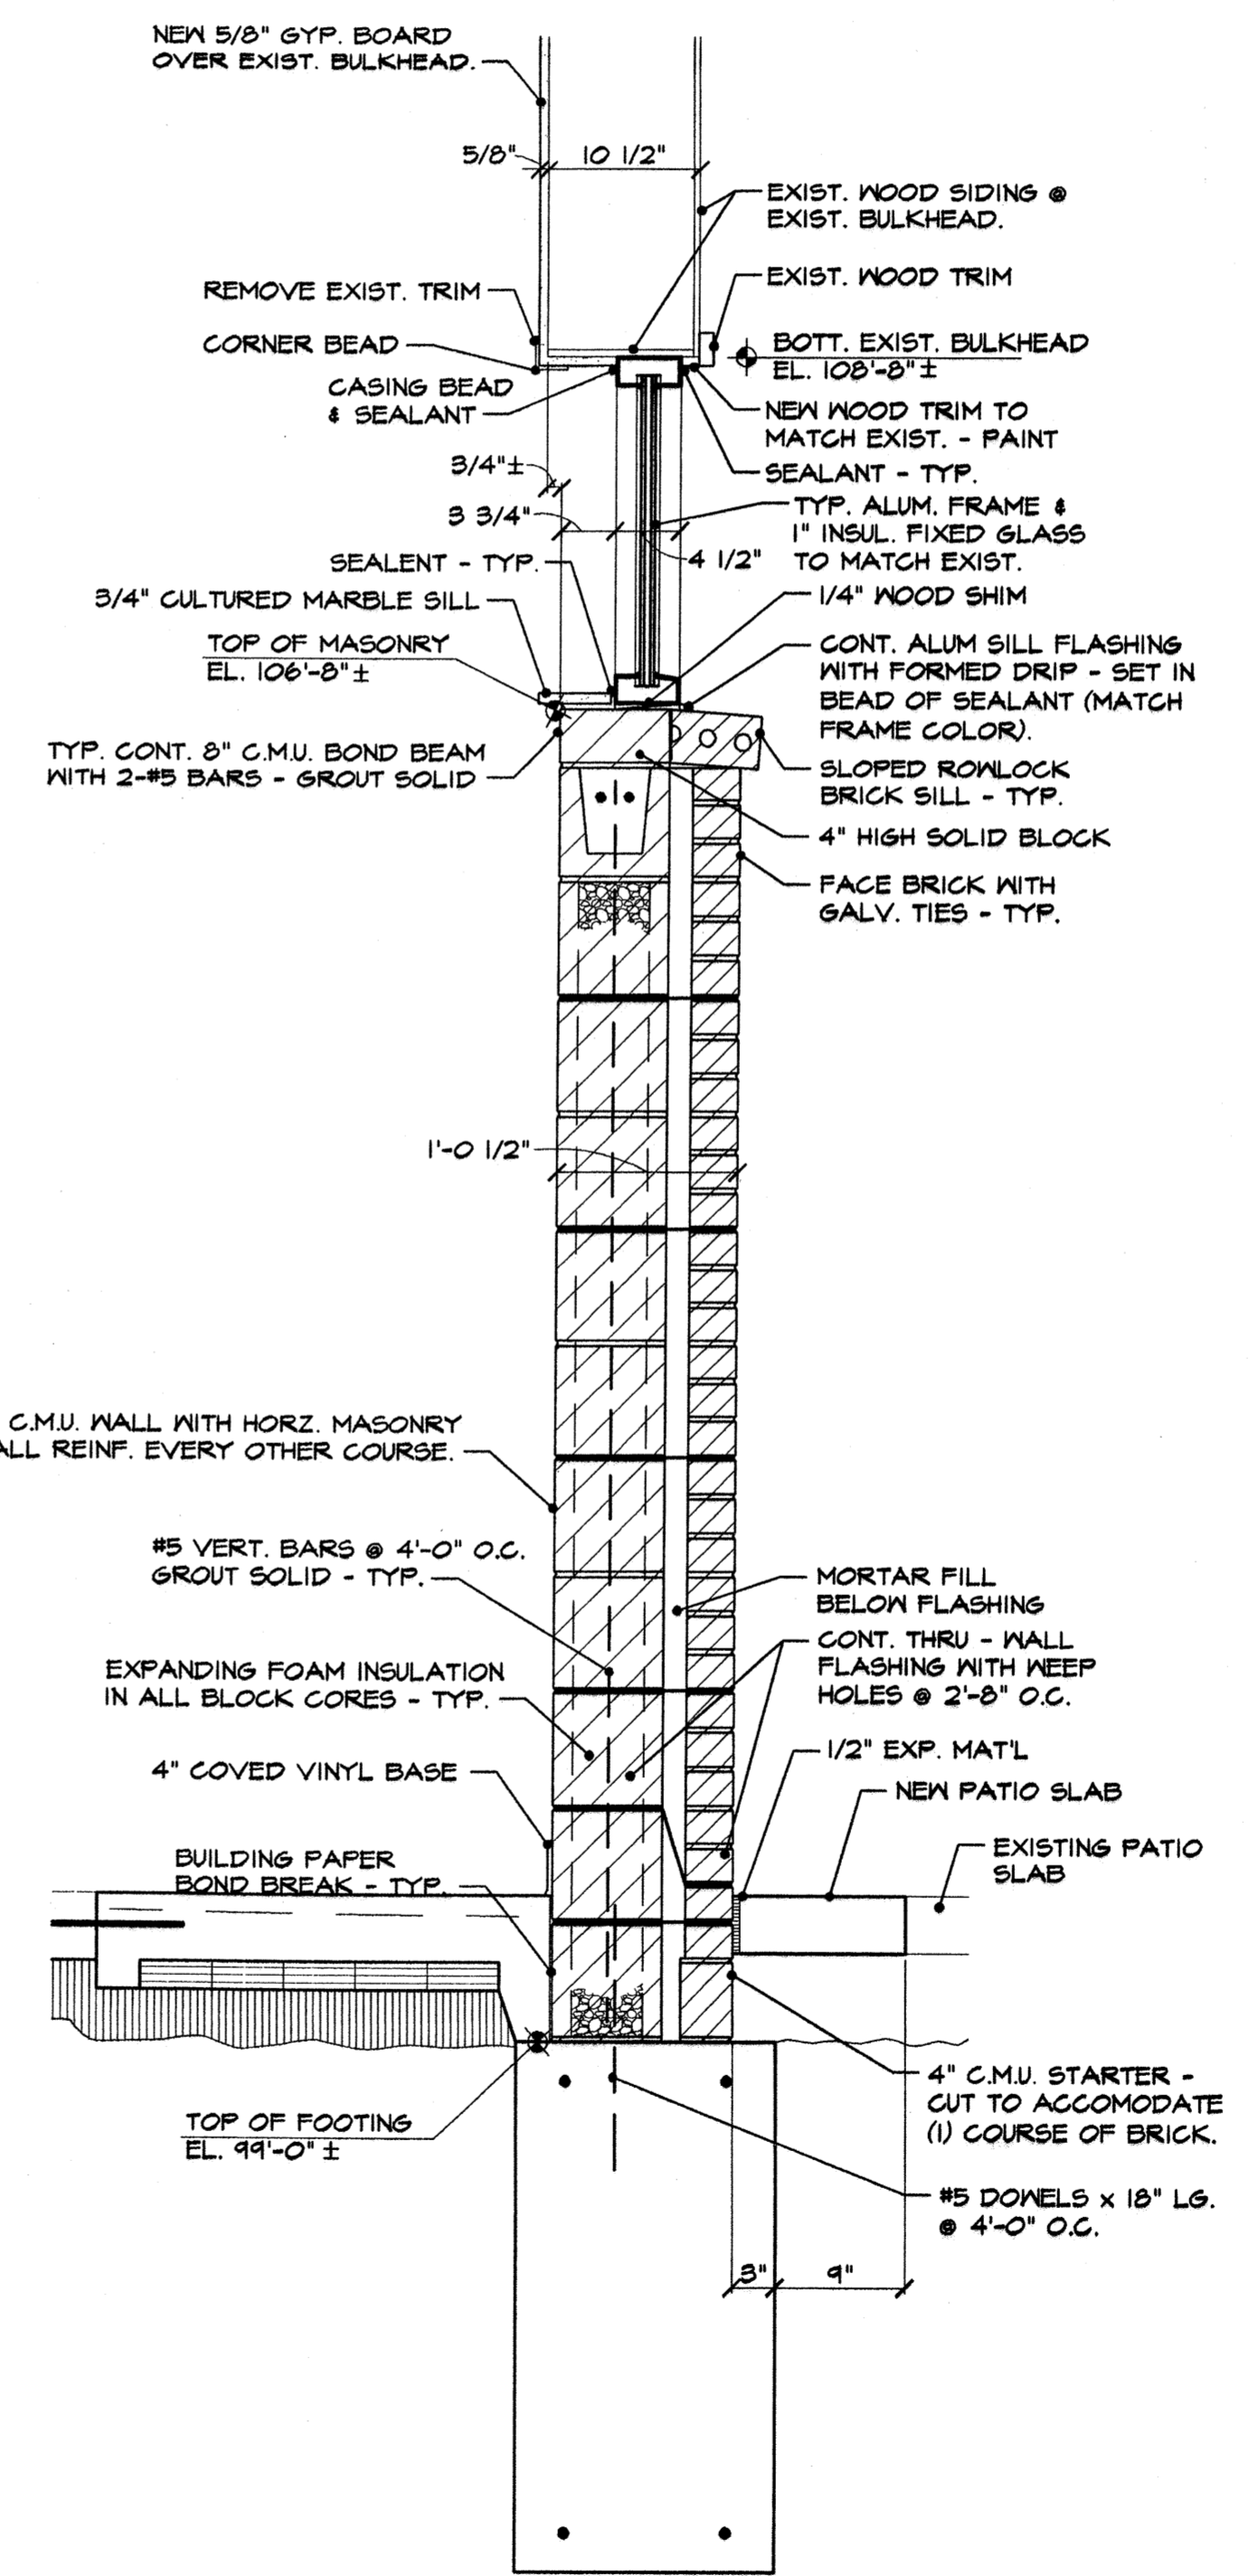


7 **DETAIL #7**
SCALE: 1 1/2" = 1'-0"

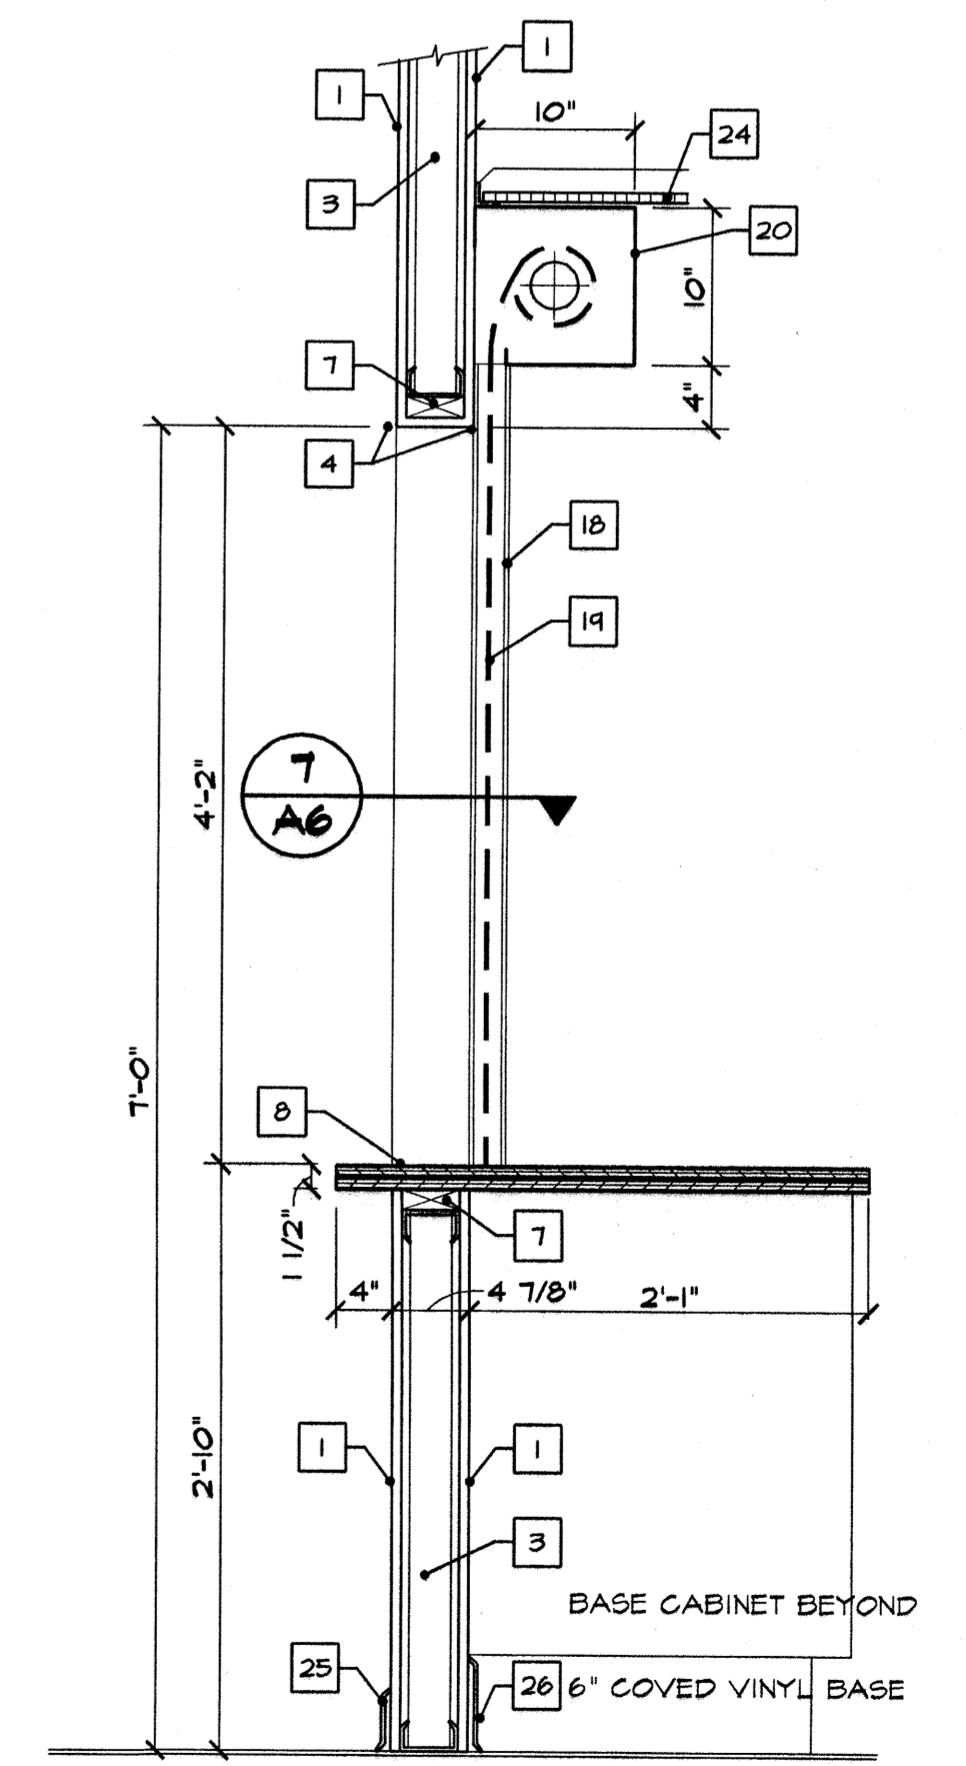

6 **ROLLING SHUTTER SECTION**
SCALE: 1" = 1'-0"

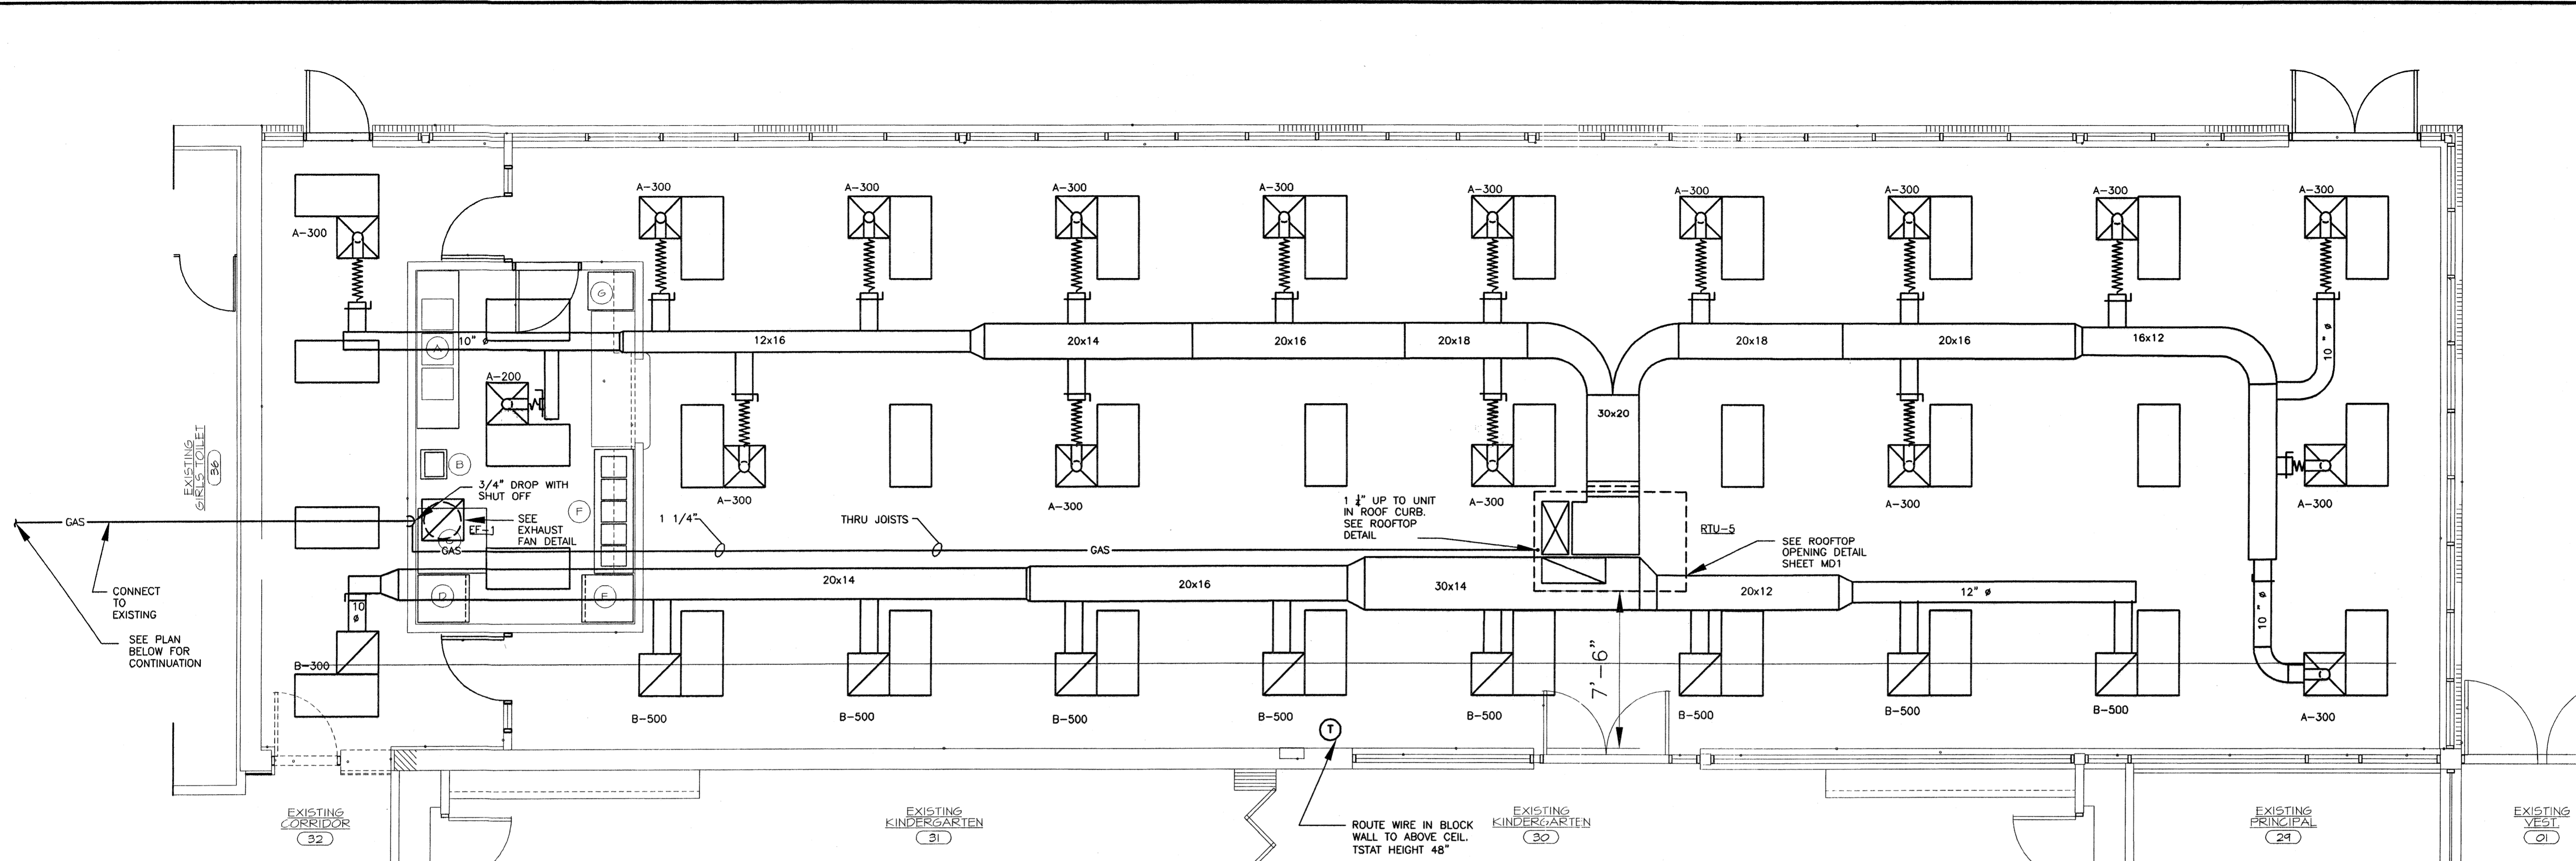

FLOOR PLAN- HVAC & GAS PIPING
SCALE 1/4" = 1'-0"

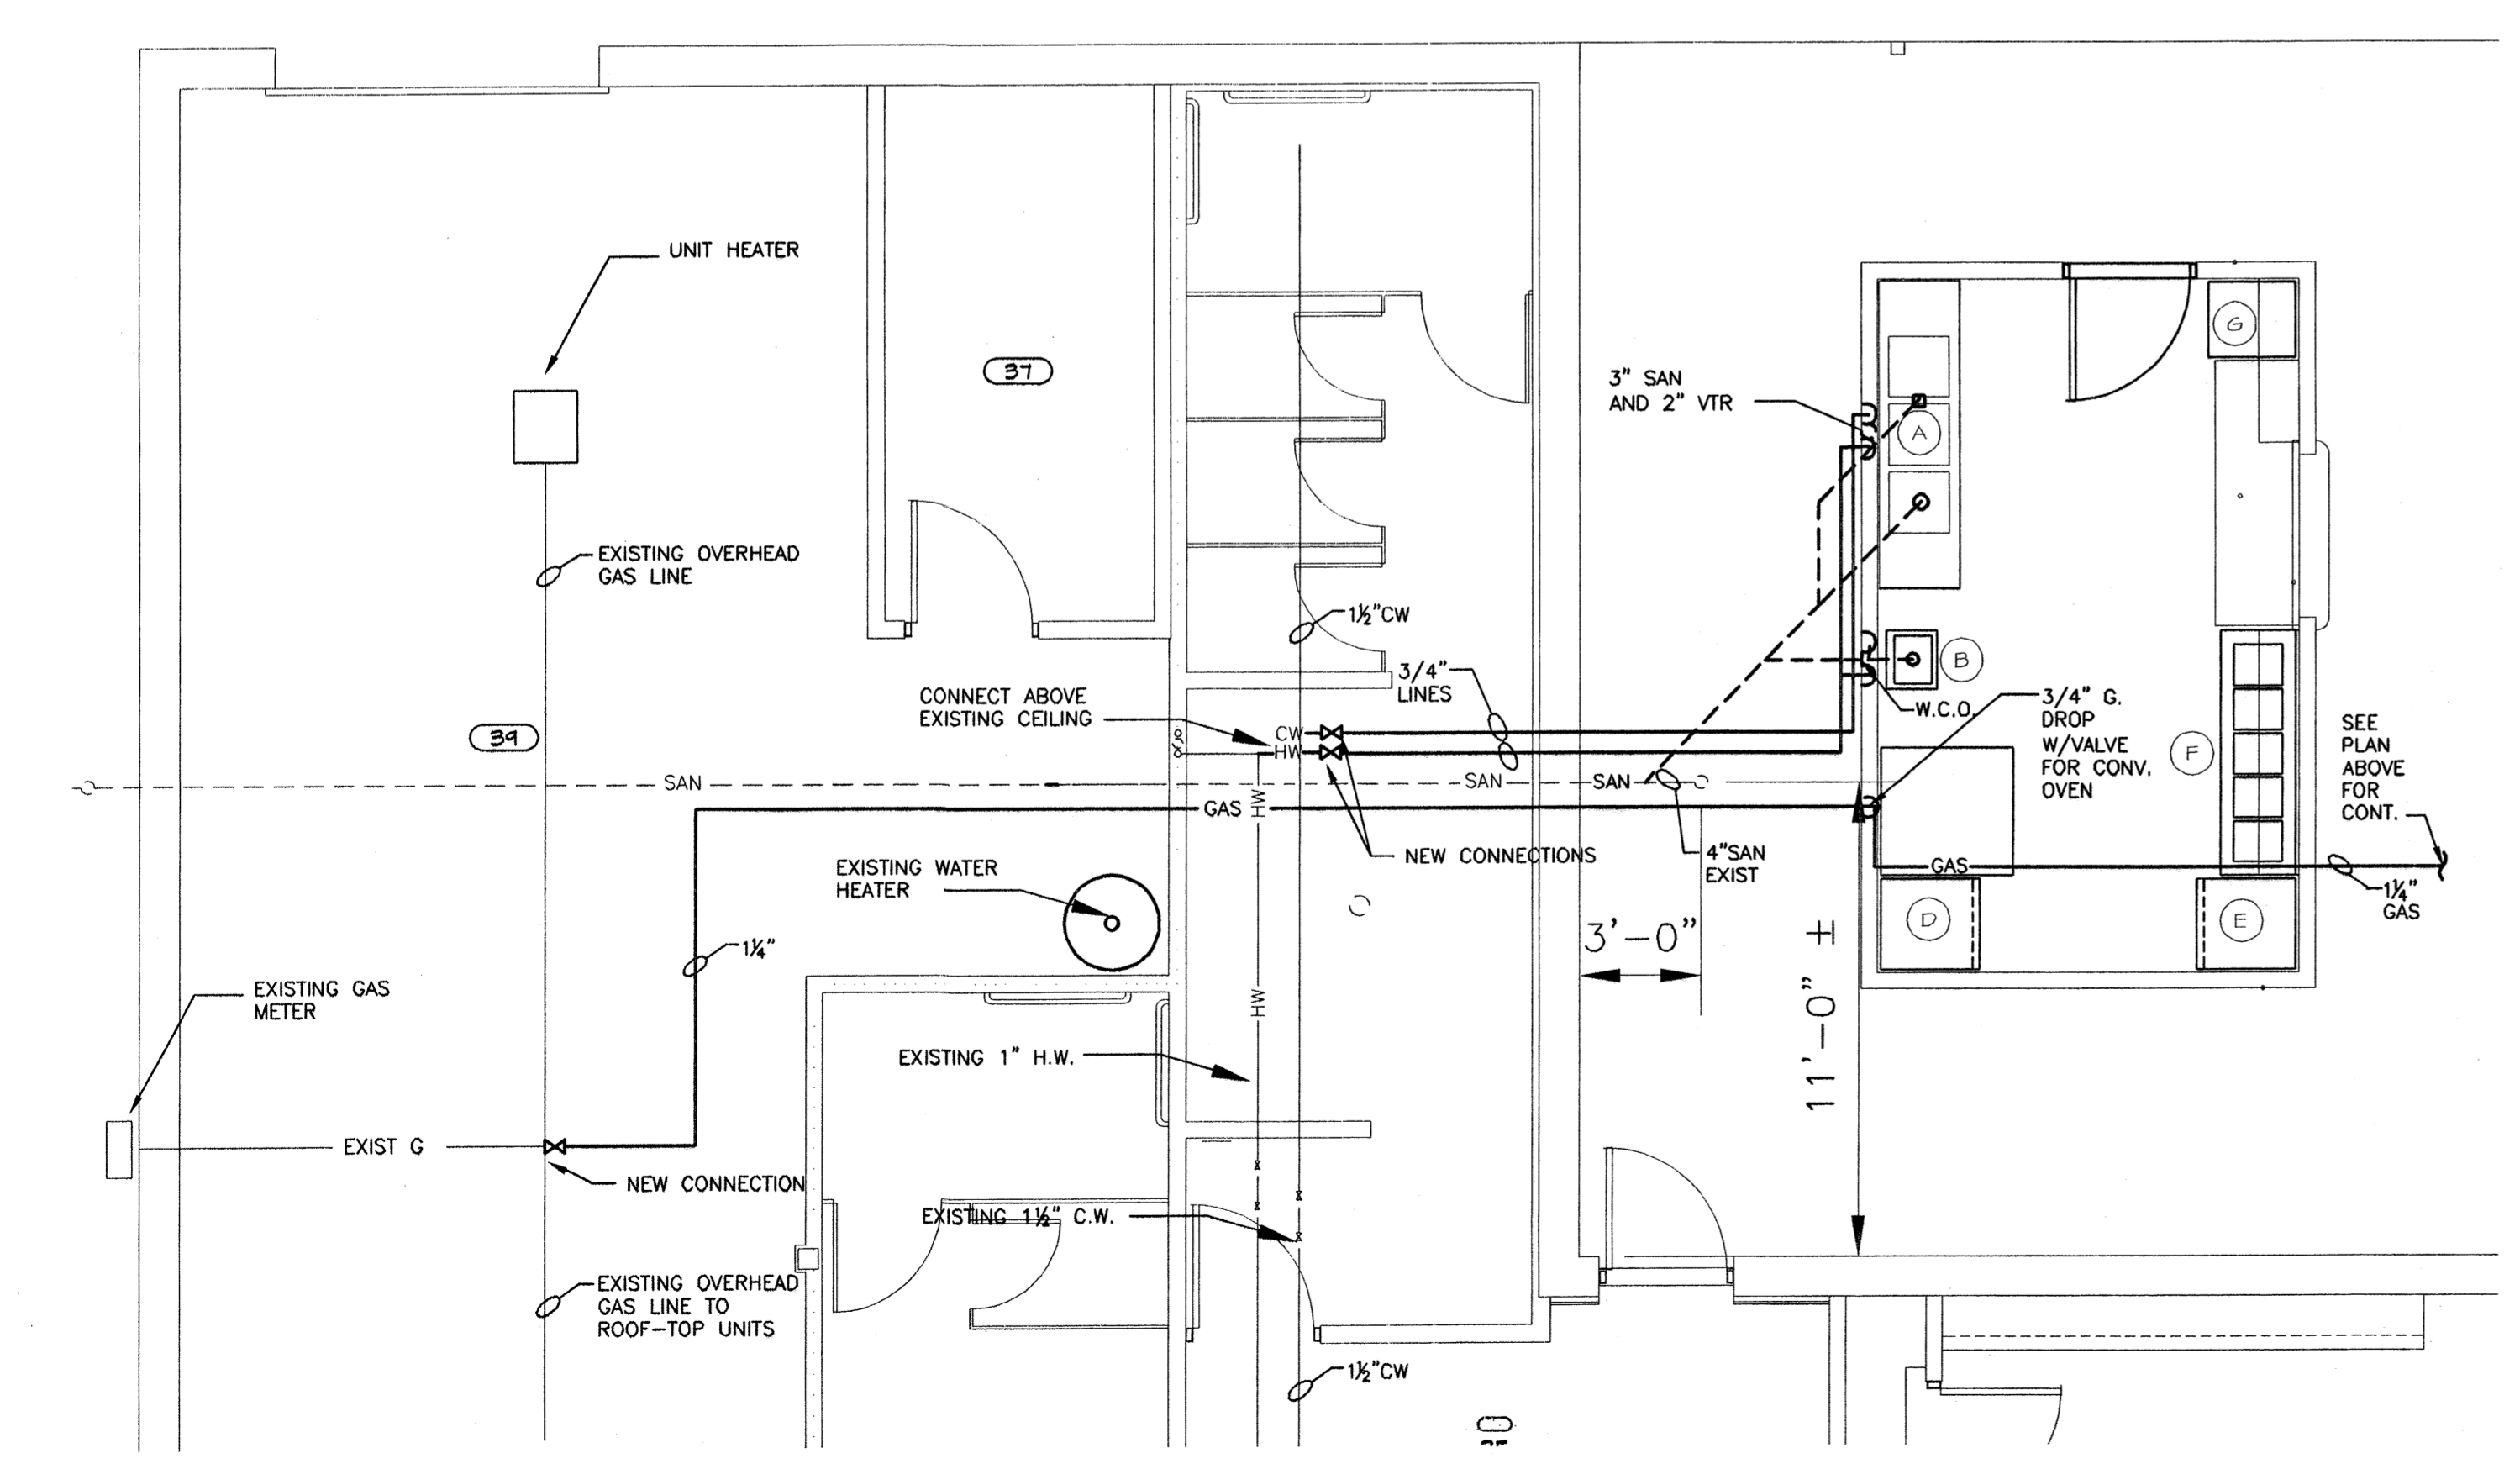

PARTIAL FLOOR PLAN- PLUMBING
SCALE 1/4" = 1'-0"

PREPARED UNDER THE SUPERVISION OF:

PROJECT LOG	ISSUED FOR PLAN REVIEW	9/19/05
FILE: 50741.0001.M1	PROJECT MGR: MMB	DESIGNED BY: MMB
	DRAWN BY: SAT	CHECKED BY:
	SCALE: 1/4" = 1'-0"	SHEET: M1 OF 1

OWNER:
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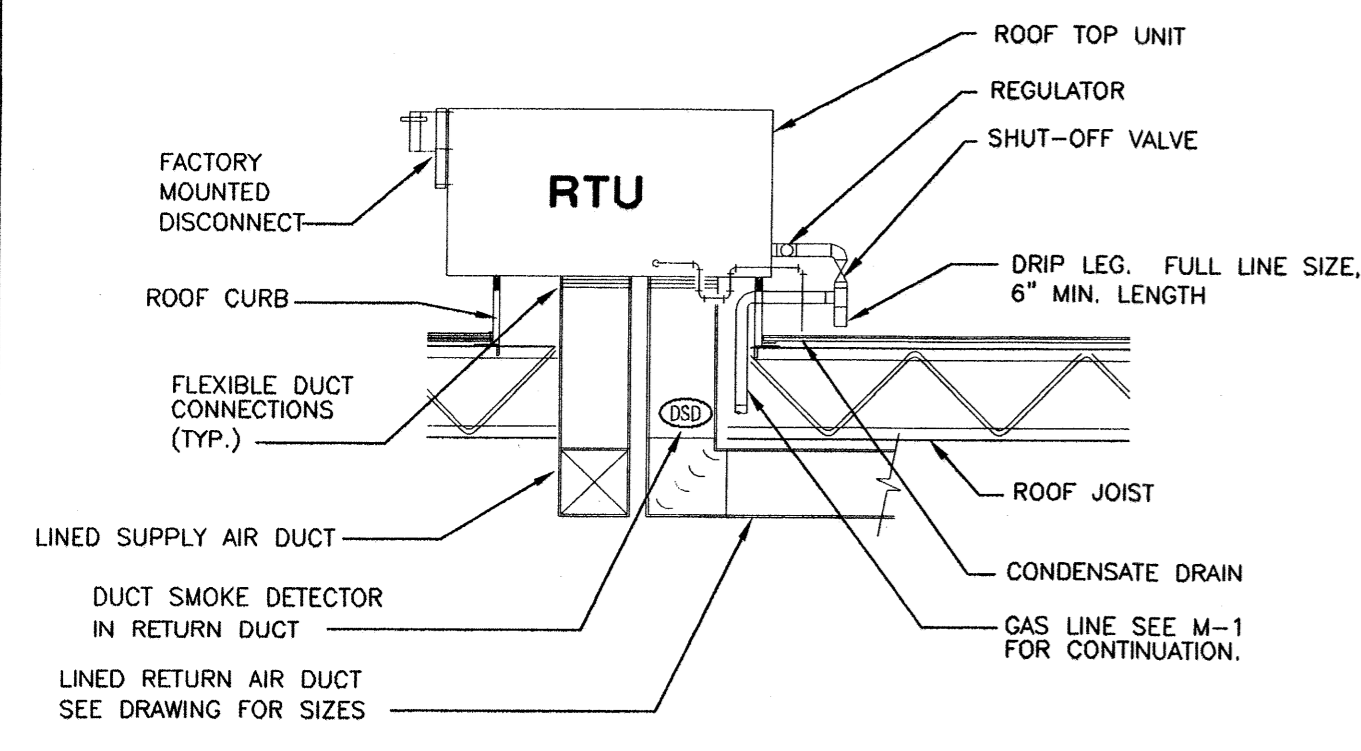
MULTI-PURPOSE ROOM ADDITION
ACADEMY OF WARREN
 13943 E. EIGHT MILE RD
 WARREN, MICHIGAN 48089
MECHANICAL / PLUMBING FLOOR PLAN

Professional Services
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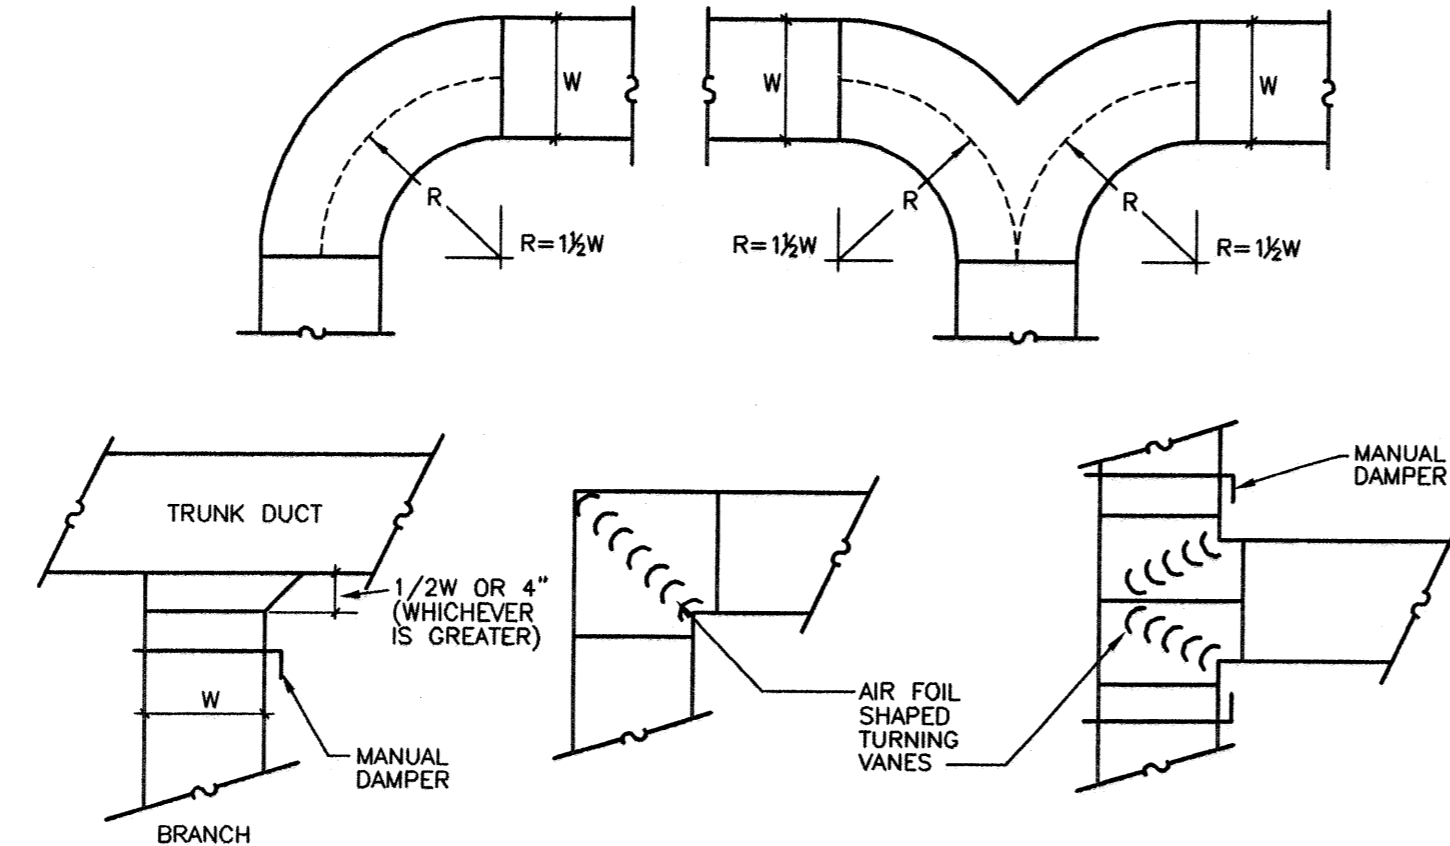


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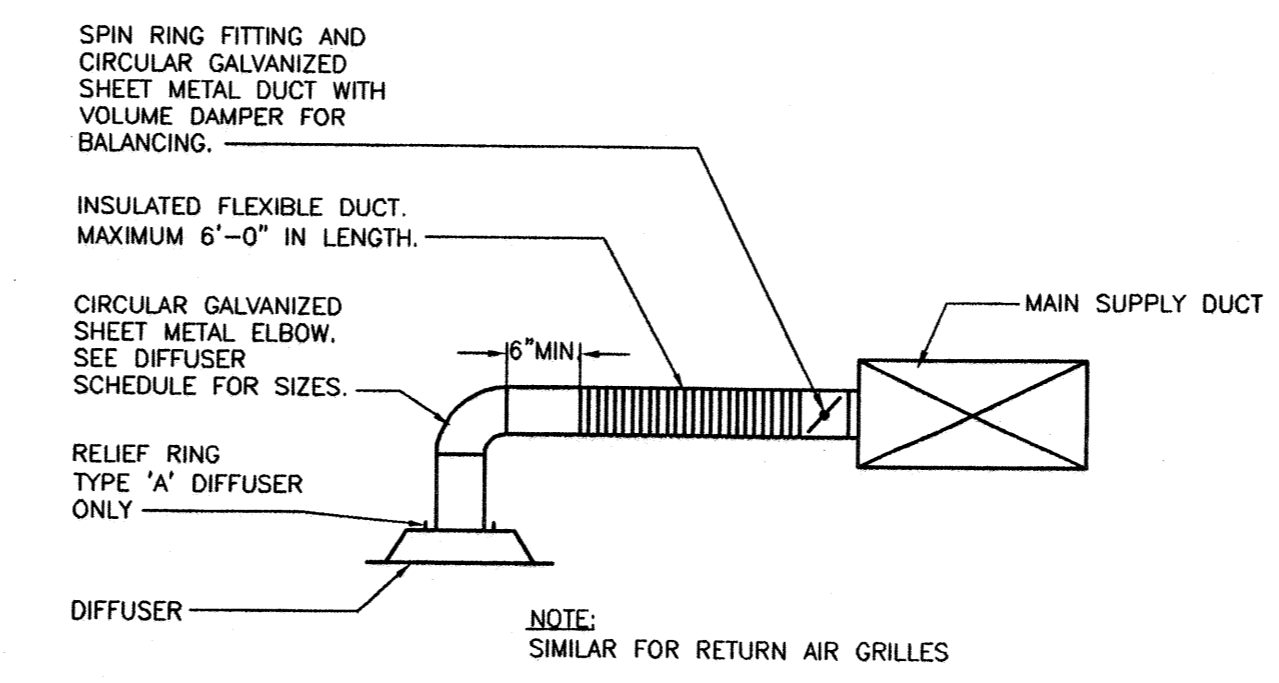
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ROOFTOP UNIT DETAIL
NOT TO SCALE



ACCEPTABLE DUCT TURNS
NOT TO SCALE



DIFFUSER CONNECTION DETAIL
NOT TO SCALE

ROOFTOP UNIT SCHEDULE

RTU-5 BRYANT MODEL# 580FPV150300KB STANDARD EFFICIENCY ROOFTOP UNIT, 12 1/2 TON, 300 MBH GAS HEAT INPUT, 208/230 VOLT, 3ø, 60 CYCLE, NATURAL GAS/DIRECT SPARK IGNITION, 1 3/4" GAS CONNECTION
PROVIDE CRRFCURB003A00 ROOF CURB TO BE SUPPLIED BY MECHANICAL CONTRACTOR AND INSTALLED AND FLASHED BY ROOFING CONTRACTOR
INSIDE DIMENSIONS OF ROOF CURB: 4'-8" x 6'-5"

- NOTES:
1. ROOF TOP UNITS SHALL HAVE DOWN FLOW ENTHALPY CONTROLLED ECONOMIZER.
 2. PROVIDE POWERED EXHAUST WITH BAROMETRIC RELIEF DAMPER.
 3. PROVIDE 2" PLEATED MEDIA FILTER, FARR 30/30.
 4. PROVIDE TIME DELAY CONTROL FOR COMPRESSORS.
 5. UNITS SHALL BE COMPLETELY PACKAGED AND WIRED FOR ALL CONTROLS. PROVIDE A CONVENTIONAL THERMOSTAT BOARD TO INTERFACE WITH A JOHNSON UNIT CONTROLLER AND SPACE SENSOR.
 6. 5 YEAR COMP. WARRANTY - CRANKCASE HEATERS, LIQUID LINE FILTER-DRYERS, LOW LIMIT DISCHARGE THERMOSTAT, ELECTRONIC COMP. PROTECTION.
 7. 10 YEAR HEAT EXCHANGER WARRANTY - AUTOMATIC SPARK IGNITION, MAIN GAS VALVE, FAN DELAY, HIGH LIMIT AND PRE-PURGE CONTROL, POWER FORCED DRAFT VENT.
 8. MOTORIZED OUTSIDE AIR DAMPER INTERLOCKED w/ UNIT OPERATION.
 9. COOLING PERFORMANCE IS RATED AT 95° AMBIENT TEMPERATURE, 80° F ENTERING DRY BULB, 67° F ENTERING WET BULB. UNITS ARE SUITABLE FOR OPERATION TO +/- 20% OF NOMINAL CFM.

- GENERAL MECHANICAL NOTES**
1. ALL WORK AND MATERIALS SHALL COMPLY WITH GOVERNING CODES, SAFETY ORDERS AND REGULATIONS.
 2. CONTRACTOR SHALL OBTAIN AND PAY FOR ALL NECESSARY PERMITS, FEES, AND INSPECTIONS REQUIRED BY GOVERNING AUTHORITIES.
 3. ALL MATERIALS AND EQUIPMENT PROVIDED AND/OR INSTALLED SHALL BE GUARANTEED FOR A PERIOD OF ONE (1) YEAR UNLESS OTHERWISE INDICATED. FROM THE DATE OF FINAL ACCEPTANCE OF THE WORK BY THE OWNER, ANY DEFECTIVE MATERIALS OR INFERIOR WORKMANSHIP SHALL BE CORRECTED TO THE ENTIRE SATISFACTION OF THE OWNER.
 4. FLEXIBLE DUCT SHALL HAVE MAX. LENGTH OF 6'-0".
 5. ALL SHEET METAL DUCTWORK SHALL BE INSTALLED IN ACCORDANCE WITH SMACNA AND/OR LOCAL AND ASHRAE CODES. TAPE ALL TRANSVERSE AND LONGITUDINAL JOINTS, AND TAKEOFFS ON SUPPLY, RETURN AND EXHAUST DUCTS. DUCT SHALL BE MILD GALVANIZED STEEL IN ACCORDANCE WITH SMACNA.
 6. WHERE INTERIOR OF DUCTWORK IS VISIBLE THRU AN AIR OUTLET OR INLET, INSIDE OF DUCT SHALL BE PAINTED WITH A FLAT BLACK PRIMER, OR INSIDE SHALL HAVE BLACK FACING.
 7. CONTRACTOR SHALL COORDINATE INSTALLATION OF ALL DUCTWORK WITH CEILING AND ROOF FRAMING. COOPERATE WITH OTHER TRADES, MAINTAIN MANUFACTURERS RECOMMENDED CLEARANCES OF ALL ITEMS OF EQUIPMENT, INSTALL TURNING VANES IN ALL 90 DEG. DUCT ELBOWS, INSTALL SPIN-IN EXTRACTOR/DAMPER AT BRANCH DUCT CONNECTION TO MAIN DUCT AND SEAL AIR TIGHT.
 8. ANY EQUIPMENT THAT IS SUBSTITUTED SHALL FIT IN THE SPACE PROVIDED, WITH ADEQUATE ROOM FOR SERVICING, INCLUDING SUBSTITUTE EQUIPMENT NAMED IN THE SPECIFICATIONS. CONTRACTOR SHALL SUBMIT A 1/4" SCALE DRAWING OF ALL EQUIPMENT SUBSTITUTED FOR APPROVAL PRIOR TO INSTALLATION.
 9. MECHANICAL CONTRACTOR SHALL START UP SYSTEM AND BALANCE AIR SIDE TO PLUS/MINUS 10% OF INDICATED AIR QUANTITIES.
 10. ALL SUPPLY, RETURN AND EXHAUST DUCT SIZES ARE INSIDE CLEAR DIMENSIONS. ALL SUPPLY AND RETURN DUCTWORK SHALL HAVE 1" THICK 1 1/2 LB. DENSITY EXTERNAL THERMAL DUCT INSULATION.
 11. SMOKE DETECTORS SHALL BE INSTALLED BY THE MECHANICAL CONTRACTOR AND CONNECTED BY THE FIRE ALARM CONTRACTOR. AT EACH AIR HANDLING SYSTEM AND 2000 CFM OR OVER, PROVIDE SMOKE DETECTOR IN THE RETURN AIR DUCT. ACTIVATION SHALL STOP THE UNIT FAN, CLOSE THE OUTDOOR AIR DAMPER AND ACTIVATE A VISIBLE AND AUDIBLE ALARM. A VISIBLE AND AUDIBLE DETECTOR TROUBLE ALARM SHALL ALSO BE PROVIDED. ALARMS SHALL BE INSTALLED IN A CONSTANTLY ATTENDED LOCATION. CONNECT TO THE FIRE ALARM SYSTEM BY FIRE ALARM CONTRACTOR.
 12. REFER TO SCHEDULES FOR MATERIALS AND EQUIPMENT REQUIREMENTS.
 13. ALL BRANCH DUCTWORK SHALL BE SAME SIZE AS DIFFUSER NECK UNLESS OTHERWISE NOTED.

EXHAUST FAN SCHEDULE

EF-1 GREENHECK MODEL CUBE-098-4, 300 CFM AT 0.25" S.P. 977 RPM 1/4 H.P., 115/160 VOLTS. PROVIDE BACKDRAFT DAMPER AND 12" HIGH ROOF CURB.

DIFFUSER AND GRILLE SCHEDULE

TYPE "A" TITUS MODEL TDC SUPPLY AIR DIFFUSER, 24"x24" SQUARE FACE, ROUND NECK, BORDER TYPE 3, 4 WAY THROW OR AS INDICATED, NECK SIZED FOR NO GREATER THAN 25 NC. SUPPLY WITH AG-75 OPPOSED BLADE DAMPER. COLOR-WHITE #26

TYPE "B" TITUS MODEL 50F ALUMINUM EGGRATE RETURN GRILLE. 1/2"x1/2"x1/2" ALUMINUM CORE, WHITE #26 COLOR, BORDER TYPE 3, 24"x24" SQUARE FACE, ROUND NECK

DIFFUSER AND GRILLE NECK SIZES

CFM RANGE	NECK SIZE
100-175	6"
176-275	8"
276-450	10"
451-600	12"
601-750	14"

FLOOR SINK SCHEDULE


FS1 FLOOR SINK SCHEDULE
JOSAM #49020ASW, SQUARE PVC 6 1/2" DEEP, 12 1/2" SQUARE. ACID RESISTING INTERIOR, DOUBLE DRAINAGE FLANG WITH WEEPHOLES, BOTTOM OUTLET.
PIPE SIZE ACCORDING TO REQUIREMENTS. 4" AIR GAP MIN.

THREE COMPARTMENT FAUCET


DELTA WALLMOUNT FAUCET 2876543, 8" CENTERS, 14" SWING NOZZLE

GENERAL PLUMBING NOTES


1. CONTRACTOR SHALL COORDINATE INSTALLATION OF PLUMBING WORK WITH ALL OTHER TRADES PRIOR TO START OF CONSTRUCTION SO AS TO AVOID UNNECESSARY DELAY OR INTERFERENCES.
2. ALL PLUMBING WORK AND MATERIALS SHALL BE INSTALLED IN ACCORDANCE WITH ALL APPLICABLE ORDINANCES, GOVERNING CODES, SAFETY ORDERS, AND REGULATIONS HAVING JURISDICTION. THE CONTRACTOR SHALL OBTAIN ALL APPROVALS REQUIRED FROM REGULATING AGENCIES BEFORE STARTING WORK.
3. CONTRACTOR SHALL OBTAIN AND PAY FOR ALL NECESSARY PERMITS, FEES, AND INSPECTIONS REQUIRED BY GOVERNING AUTHORITIES.
4. DOMESTIC WATER PIPING: ABOVE GROUND COPPER TYPE "L".
5. GAS PIPING: INSIDE BUILDING ABOVE GROUND, SCHEDULE 40 BLACK STEEL PIPE.
6. INSULATE DOMESTIC HOT/COLD WATER PIPING WITH 1/2" THICK MICRO-LOK FIBER GLASS PIPE INSULATION BY JOHNS-MANVILLE PIPE INSULATION OR APPROVED EQUIVALENT.
7. ALL PIPING SHALL BE KEPT TIGHT TO UNDERSIDE OF STRUCTURE AND SECURED IN ACCORDANCE WITH ALL APPLICABLE CODES.
8. SOME VENTS AND CLEANOUTS MAY BE OMITTED FOR DRAWING CLARITY. PROVIDE AND INSTALL ALL VENTS AND CLEANOUTS REQUIRED IN ACCORDANCE WITH ALL APPLICABLE CODES.
9. SANITARY PIPING SHALL HAVE A MINIMUM OF 1/8" PER FOOT SLOPE.
10. SANITARY VENTS THROUGH ROOF SHALL TERMINATE A MINIMUM OF 1 FOOT ABOVE THE ROOF.
11. MECHANICAL AND PIPING PLANS ARE DIAGRAMMATIC IN NATURE. INTENDED TO INDICATE DESIGN INTENT ONLY. CONTRACTOR IS RESPONSIBLE TO COORDINATE SPECIFIC LOCATIONS OF ITEMS AND ADJUST AS REQUIRED TO ACCOMMODATE CONSTRUCTION CONDITIONS, CODES REQUIREMENTS AND THE WORK OF OTHER TRADES.

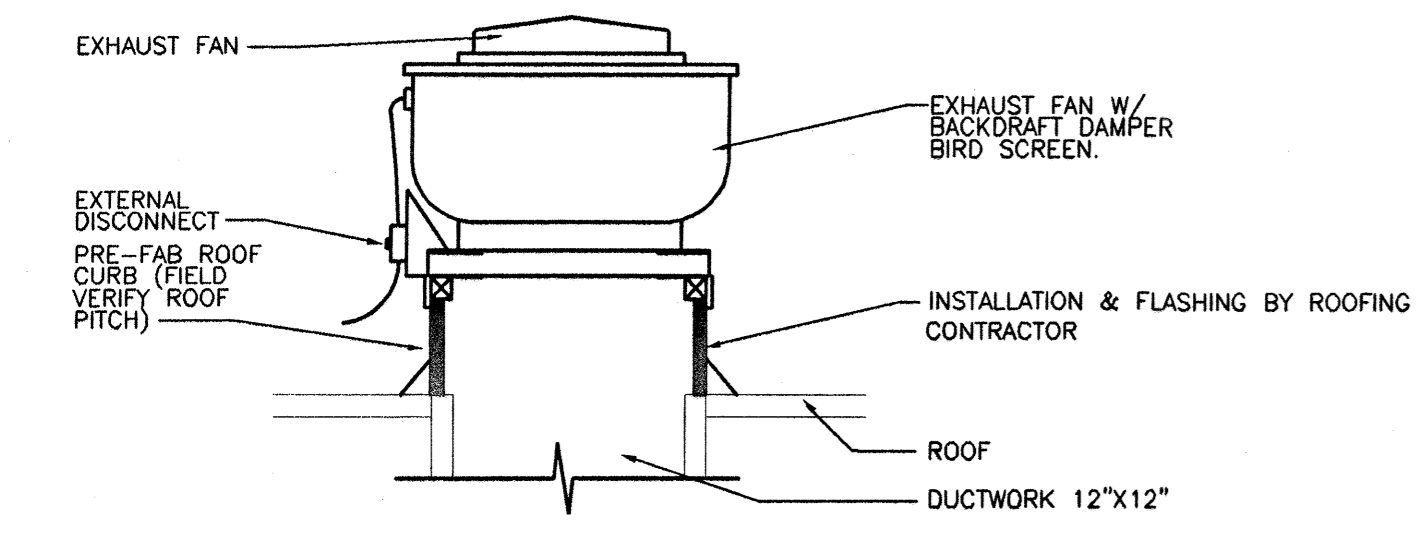

EXHAUST FAN DETAIL
NOT TO SCALE

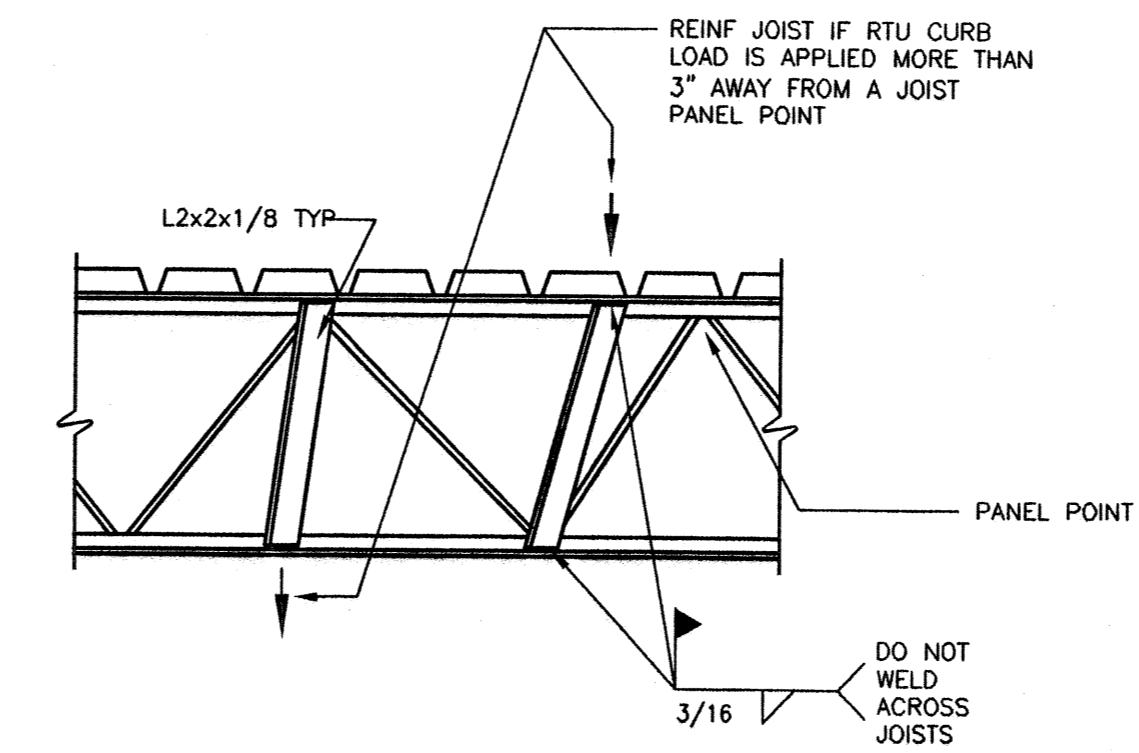

(A) TYPICAL JOIST REIN AT CONCENTRATED LOADS
SCALE: 1" = 1'-0"

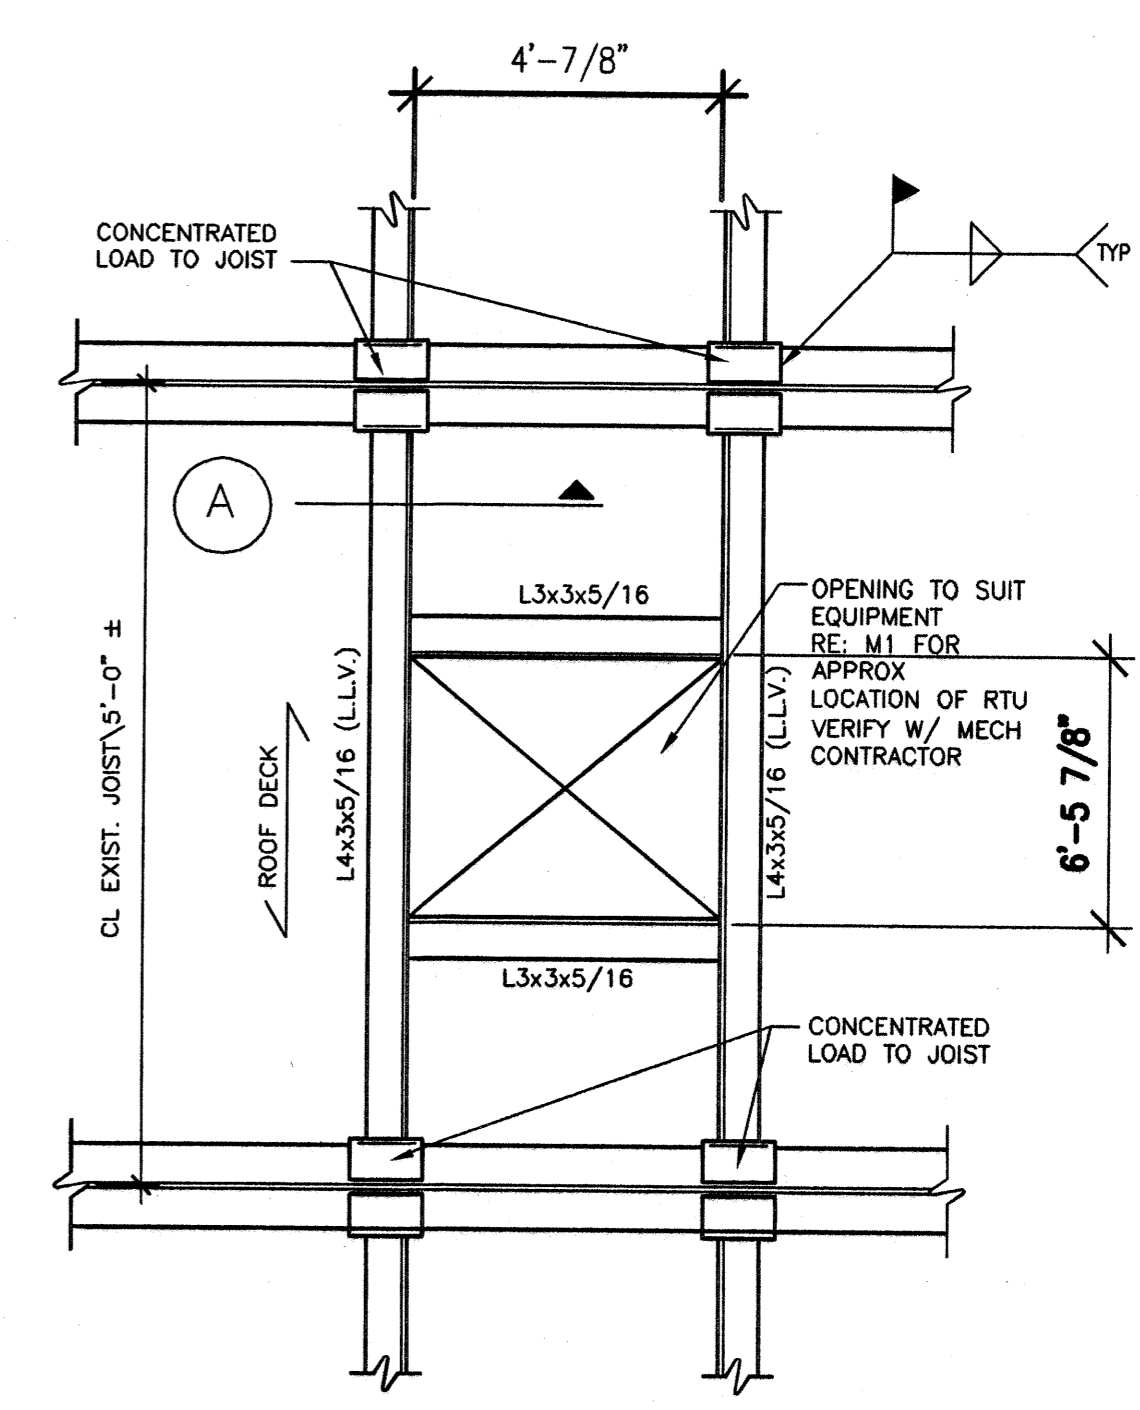

(B) ROOF OPENING FRAME (RTU #5)
SCALE: 1" = 1'-0"

PREPARED UNDER THE SUPERVISION OF: _____

PROJECT LOG

FILE: 50741.0001\MD1	DESIGNED BY: MMB	SCALE: NONE	SHEET: MD1 OF 1
PROJECT MGR: MMB	DRAWN BY: SAT	CHECKED BY: _____	
ISSUED FOR PLAN REVIEW: 9/7/05			

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(248) 768-4401

**MULTI-PURPOSE ROOM ADDITION
ACADEMY OF WARREN**
13943 E. EIGHT MILE RD
WARREN, MICHIGAN 48089


MECHANICAL / PLUMBING DETAILS

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Wilcox

MD1

50741.0001

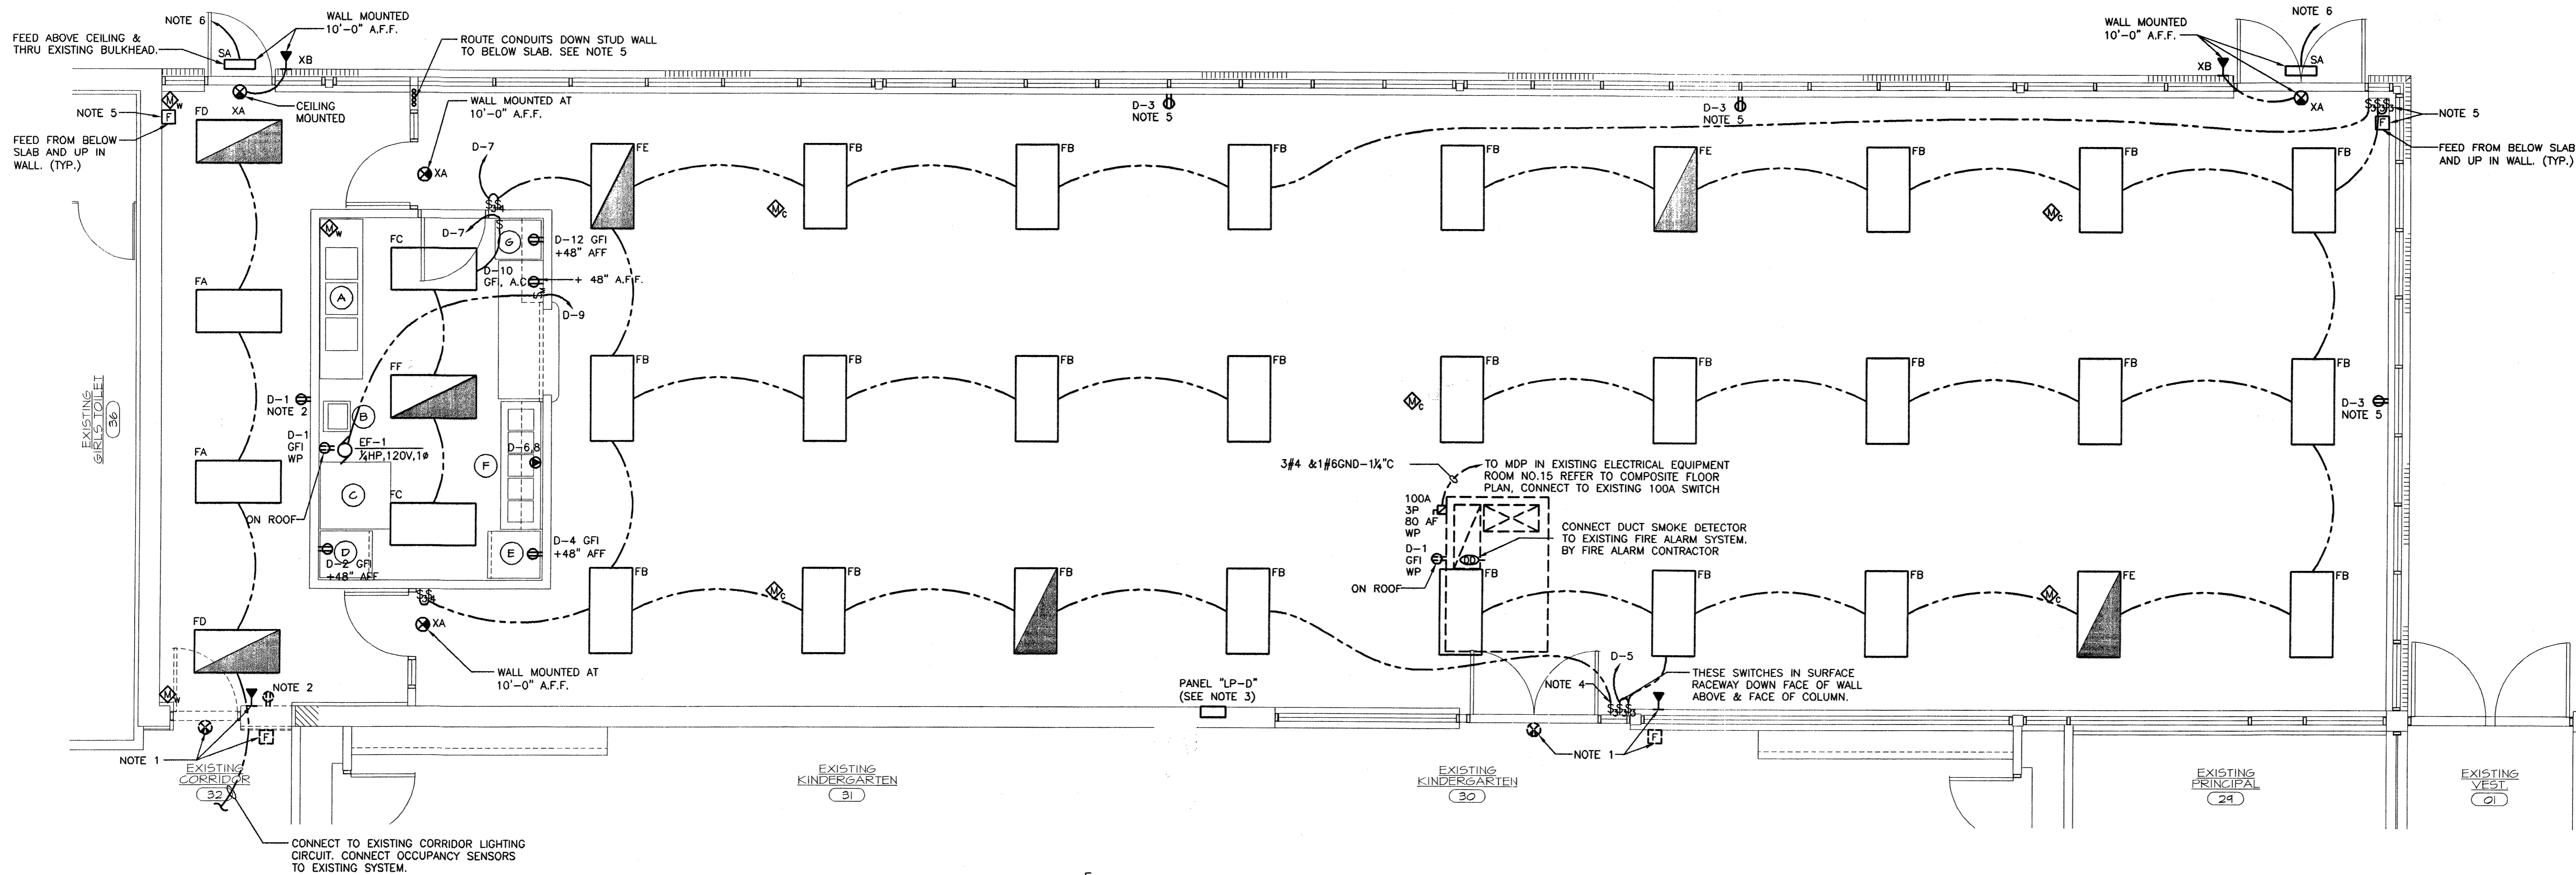

FLOOR PLAN - ELECTRICAL
SCALE: 1/4" = 1'-0"

NOTES:

- RELOCATE EXISTING EXIT SIGN, EXTERIOR EMERGENCY LIGHT AND FIRE ALARM PULL STATION TO NEW EXIT DOOR. PULL STATION BY FIRE ALARM CONTRACTOR.
- RELOCATE RECEPTACLE TO CORRIDOR. CONNECT TO NEW CIRCUIT INDICATED.
- REMOVE EXISTING ELECTRICAL PANEL AND INSTALL NEW PANEL TO FIT 20" X 29" X 6" DEEP OPENING, SQUARE D NOD20L100. FILL IN UNDER PANEL TO MATCH EXISTING BLOCK WALL. ROUTE 4# 1#10GND-1" C INSIDE EXISTING BLOCK WALL FROM PANEL LP-C. IN EXISTING ELECTRICAL EQUIPMENT ROOM NO. 15 - REFER TO COMPOSITE FLOOR PLAN. INSTALL 50A 3 POLE BREAKER IN FIRST AVAILABLE SPACE IN PANEL 'LP-C'.
- SURFACE MOUNT SWITCHES ON WALL. ROUTE SURFACE MOUNTED RACEWAY ALONG COLUMN TO ABOVE CEILING AND CONNECT TO CONDUIT.
- ROUTE 3/4" CONDUIT FOR DEVICE AND CIRCUIT IN STUD WALL WHERE INDICATED AND ROUTE CONDUIT UNDER FLOOR SLAB AND UP IN NEW OR EXISTING BLOCK WALL TO OUTLET BOX.
CONNECT TO NEAREST EXISTING EXTERIOR LIGHTING CIRCUIT ON EAST WALL APPROXIMATELY SOFT TO THE NORTH OF THE NORTHEAST EXIT DOOR.

LIGHT FIXTURE SCHEDULE

TYPE	LAMPS	DESCRIPTION
FA	2-F32T8/41K	2'x4' FLUORESCENT LAY-IN FIXTURE WITH TWO (2) T-8 LAMPS. FLUSH STEEL LENS FRAME, 125" #12 PATTERN ACRYLIC PRISMATIC LENS AND 120 VOLT SOLID STATE BALLAST. LITHONIA CAT. #2GT8-2-32-A12125-120-GE8 OR ENGINEER ACCEPTED SUBSTITUTE.
FB	3-F32T8/41K	2'x4' FLUORESCENT LAY-IN FIXTURE WITH THREE (3) T-8 LAMPS. FLUSH STEEL LENS FRAME, 125" #12 PATTERN ACRYLIC PRISMATIC LENS AND TWO 120 VOLT SOLID STATE BALLASTS. LITHONIA CAT. #2GT8-3-32-A12125-120-(2)GE8 OR ENGINEER ACCEPTED SUBSTITUTE.
FC	3-F32T8/41K	SAME AS TYPE 'FB' EXCEPT WITH ADDITIONAL LENS GASKETING AND ONE 120 VOLT SOLID STATE BALLAST. LITHONIA CAT. #2GT8-3-32-A12125-120-GE8-LG OR ENGINEER ACCEPTED SUBSTITUTE.
FD	2-F32T8/41K	SAME AS TYPE 'FA' EXCEPT WITH 1400 LUMEN OUTPUT BATTERY SYSTEM. LITHONIA CAT. #2GT8-2-32-A12125-120-GE8-EL14 OR ENGINEER ACCEPTED SUBSTITUTE.
FE	3-F32T8/41K	SAME AS TYPE 'FB' EXCEPT WITH 1400 LUMEN OUTPUT BATTERY SYSTEM. LITHONIA CAT. #2GT8-3-32-A12125-120-(2)GE8-EL14 OR ENGINEER ACCEPTED SUBSTITUTE.
FF	3-F32T8/41K	SAME AS TYPE 'FC' EXCEPT WITH 1400 LUMEN OUTPUT BATTERY SYSTEM. LITHONIA CAT. #2GT8-3-32-A12125-120-GE8-LG-EL14 OR ENGINEER ACCEPTED SUBSTITUTE.
SA	1-LU70	70 WATT HIGH PRESSURE SODIUM WALL PACK WITH 120 VOLT HIGH POWER FACTOR BALLAST, RUGGED DIE-CAST ALUMINUM HOUSING AND PRISMATIC BOROSILICATE REFRACTOR. LITHONIA CAT. #TWH-70S-120-LPI OR ENGINEER ACCEPTED SUBSTITUTE.
XA	LED	LED EXIT SIGN WITH WHITE THERMOPLASTIC HOUSING, SINGLE FACE STENCIL RED LETTERING, NO SIDE MOUNT LAMPS, HIGH OUTPUT LEAD CALCIUM BATTERY, CEILING OR BACK MOUNTING. LITHONIA CAT. #LHOM-S-W-1-R-120/277-HO-RO OR ENGINEER ACCEPTED SUBSTITUTE.
XB	1-MR24 KRYPTON	REMOTE EMERGENCY LAMP, SINGLE HEAD, MULTI-FACETED REFLECTOR, 6V, 9W, MOUNTED AT 10'-0" A.F.F. LITHONIA CAT. #ELA-MR24-K9086 OR ENGINEER ACCEPTED SUBSTITUTE.

SCHEDULE OF PANEL 'LP-D'

VOLTAGE RATING: 120/208V		PHASE: THREE		WIRE: FOUR			
MIN. BUSS AMPS: 100 A		MAIN DEVICE AMPS: M.L.O.					
BREAKER A.I.C.: 10,000		MOUNTING: RECESSED					
LOCATION DESCRIPTION	LOAD (KVA)	DEVICE AMPS/P	#	PH	LOAD (KVA)	LOCATION DESCRIPTION	
RECEPTS	0.360	20	1	2	20	0.080	FREEZER
RECEPTS	0.540	20	3	4	20	0.960	REFRIGERATOR
LIGHTS	1.350	20	5	6	25	1.875	FOOD TABLE
LIGHTS	1.350	20	7	8	25	1.875	
EF-1	0.667	20	9	10	20	0.180	COUNTER RECEPT
SPACE			11	12	20	0.180	WALL RECEPT
			13	14			SPACE
			15	16			
			17	18			
			19	20			
NOTES:				TOTAL CONNECTED LOAD: 10.417 KVA			
				TOTAL DEMAND LOAD: 7.292 KVA			

PANEL	EXISTING CONNECTED LOAD (KVA)	NEW CONNECTED LOAD (KVA)	NEW CONNECTED LOAD (KVA)
MDP	142.808	165.504	148.154
PANEL LP-C	27.818	38.235	24.342

ELECTRICAL LEGEND

	LIGHT FIXTURES - LETTERS INDICATE TYPE AND CIRCUIT, SHADING INDICATES EMERGENCY FIXTURE		MANUAL MOTOR STARTER		CIRCUIT BREAKER, RATINGS AS INDICATED
	LIGHT FIXTURES - LETTERS INDICATE TYPE		CEILING MOUNTED DUPLEX RECEPTACLE		NOTATION OF ELECTRICAL DEVICE TO REMAIN
	LIGHT FIXTURE, LETTER INDICATES TYPE.		DUPLEX RECEPTACLE, MOUNT @ 18" AFF UNLESS INDICATED OTHERWISE		NOTATION OF ELECTRICAL DEVICE TO BE REMOVED
	WALL MOUNTED LIGHT FIXTURE, LETTER INDICATES TYPE.		DUPLEX RECEPTACLE WITH GROUND FAULT PROTECTION, MOUNT @ 18" AFF UNLESS INDICATED OTHERWISE.		NOTATION OF EXISTING ELECTRICAL DEVICE TO BE RELOCATED
	RECESSED WALL WASH FIXTURE, LETTER INDICATES TYPE.		RECEPTACLE, PLUGMOLD, TWOPIECE, 12 INCH CENTERS		MOUNTED 6" ABOVE COUNTER TOP
	RECESSED LIGHT FIXTURE, CEILING OR SOFFIT MOUNTED, LETTER INDICATES TYPE.		SURGE SUPPRESSION DUPLEX RECEPTACLE, MOUNT @ 18" AFF UNLESS INDICATED OTHERWISE.		WEATHER PROOF
	TRACK LIGHTING, LETTER INDICATES TYPE		FLOOR RECEPTACLE		DISTRIBUTION PANEL
	SINGLE FACE EXIT SIGN, SHADING INDICATES FACE, ARROW AS INDICATED, LETTER INDICATES TYPE.		QUADRUPLEX RECEPTACLE, MOUNT @ 18" AFF UNLESS INDICATED OTHERWISE		PANELBOARD
	DOUBLE FACE EXIT SIGN, SHADING INDICATES FACE, ARROW AS INDICATED, LETTER INDICATES TYPE.		COMBINATION FLOOR BOX, WALKER CAT. # RFB4 WITH TWO (2) PLATES. ONE FOR DUPLEX RECEPTACLE AND ONE FOR COMBINATION TELE/DATE OUTLETS AND CARPET INSERT COVER.		TELEPHONE BACKBOARD
	SINGLE POLE SWITCH, MOUNT @ 48" AFF UNLESS INDICATED OTHERWISE.		FLOOR BOX, WALKER CAT. # RFB4 WITH ONE (1) PLATE FOR DUPLEX RECEPTACLE EACH		CONTROL PANEL
	THREE WAY SWITCH, MOUNT @ 48" AFF UNLESS INDICATED OTHERWISE.		30 AMP RECEPTACLE, 208 VOLT, SINGLE PHASE		JUNCTION BOX
	FOUR WAY SWITCH, MOUNT @ 48" AFF UNLESS INDICATED OTHERWISE.		30 AMP RECEPTACLE, 120 VOLT, SINGLE PHASE		FIRE ALARM CONTROL PANEL
	OCCUPANCY SENSOR WALL SWITCH WATT STOPPER CAT.#WA-200		TELEPHONE OUTLET, MOUNT @ 18" AFF UNLESS INDICATED OTHERWISE.		FIRE ALARM VISUAL ANNUNCIATOR (cd) STROBE, CANDELA RATING AS NOTED
	ULTRASONIC OCCUPANCY SENSOR WITH POWER PACK, CEILING MOUNTED WATT STOPPER CAT.# WT-1105 FOR SENSOR AND CAT.# BZ-100 FOR POWER PACK.		WALL MOUNTED TELEPHONE OUTLET, MOUNT @ 48" AFF UNLESS INDICATED OTHERWISE		FIRE ALARM AUDIO/VISUAL ANNUNCIATOR (cd) STROBE, CANDELA RATING AS NOTED
	DUAL TECHNOLOGY OCCUPANCY SENSOR WITH POWER PACK, CEILING MOUNTED WATT STOPPER CAT.# DT-300 FOR SENSOR AND CAT.# BZ-100 FOR POWER PACK		DATA OUTLET, MOUNT @ 18" AFF UNLESS INDICATED OTHERWISE.		CEILING MOUNTED SMOKE DETECTOR
	DUAL TECHNOLOGY SENSOR WITH POWER PACK, WALL MOUNTED WATT STOPPER CAT.# DT-200 FOR SENSOR AND CAT.# BZ-100 FOR POWER PACK.		WALL MOUNTED TELEPHONE OUTLET, MOUNT @ 18" AFF UNLESS INDICATED OTHERWISE.		CEILING MOUNTED HEAT DETECTOR
			TV VIDEO OUTLET.		FIRE ALARM PULL STATION
			WALL MOUNTED EMERGENCY LIGHT.		DUCT SMOKE DETECTOR
					FIRE PROTECTION FLOW OR TAMPER SWITCHES.
					FUSED DISCONNECT SWITCH

PREPARED UNDER THE SUPERVISION OF:

PROJECT LOG

FILE: 50741.0001/E1	ISSUED FOR REVIEW: 9/15/05
PROJECT MGR: MRC	DESIGNED BY: MRC
DRAWN BY: DCH	CHECKED BY:
SCALE: 1/4"=1'-0"	SHEET: E1 OF 2

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MULTI-PURPOSE ROOM ADDITION ACADEMY OF WARREN
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E1

50741.00011

WORK INCLUDED

The Electrical Contractor shall provide all items, articles materials, operations, or methods mentioned, listed, or scheduled on the drawings and in these specifications, including labor, materials, equipment, and incidentals necessary required for the completion and operation of all systems.

LOCAL CONDITIONS

The Electrical Contractor shall visit the site and shall familiarize himself with conditions which will affect the work he is to perform.

PERMITS AND INSPECTIONS

The Electrical Contractor shall take out all permits required and arrange for all necessary inspections and shall pay all fees and expenses in connection therewith as a part of their work under their Contract.

Upon completion of the work, they shall furnish to the Owner all certifications of inspection and approval which are customary for the classes of work involved.

RULES, CODES AND STANDARDS

All work shall be performed or installed in strict accordance with all applicable rules, regulations and codes of Local, State and Federal Governments, or other authorities having lawful jurisdiction, and each Contractor and Subcontractor shall be responsible for such compliance.

All electrical work and equipment shall conform to the requirements of the current issue of the National Electrical Code, and shall bear label of inspection and approval of the Underwriters' Laboratories.

EXTRA WORK

For any extra electrical work which may be proposed, this Contractor shall furnish to the Engineer an itemized breakdown of the estimated cost of materials and labor required to complete this work. To this cost shall be added a percentage to cover all items of insurance, overhead and profit as listed in Contractor's Proposal. The Electrical Contractor shall proceed only after receiving a written order from the Engineer establishing the agreed price and describing the work to be done.

SCHEDULE OF WORK

The Electrical Contractor shall expedite his work in order to conform to the Owner's schedule and where necessary shall work overtime at his own expense so that all work may be completed within the time outlined.

CUTTING AND PATCHING

No cutting and burning of holes through beams or other structural members shall be done without the specific permission of the Architect.

All openings in walls, ceilings, or floors made by the Electrical Contractor shall be neatly patched by him after other work is done. At the discretion of the Architect, cutting and patching of work in place shall be done by the Trade whose work is done, but the cost of such work shall be paid for by the Electrical Contractor.

All measurements necessary for the proper installation of materials or apparatus shall be taken in the field. The Contractor shall be held responsible for the correct fit of work installed.

GUARANTEE AND WARRANTY

Contractor shall guarantee all work installed by him or his Subcontractors to be free from defect in material and workmanship for a period of one year following the date of final acceptance of the work, and he shall repair or replace at no additional cost to the Owner, any material or equipment developing defects and shall also make good any damage caused by such defects or the correction of defects. Repairs or replacements shall bear additional twelve (12) months guarantee, as originally called for, dated from the final acceptance of the repair or placement. This requirement shall be binding even though it will exceed products guarantees normally furnished by some manufacturers.

Contractor shall submit his own and each equipment manufacturer's written certificates, warranting that each item or equipment furnished complies with all requirements of the Drawings and Specifications.

Note that guarantee shall run from date of final acceptance of the work, not from date of installations of a device or piece of equipment.

REMODELING AND DEMOLITION WORK

Remove all existing wire, conduit, and electrical devices conflicting with construction; where old facilities are indicated to be removed; and where new facilities replace old installations.

Furnish and install new conduit and wiring to replace existing conduit and wiring abandoned or removed as part of the project where required.

Extend the existing conduit system or install new conduit and wire to provide electrical service to new devices or existing devices where required.

All existing, exposed conduit abandoned as part of the project shall be removed. All unused openings in junction or pull boxes and device boxes shall be closed with a suitable cover or plug.

All electrical equipment and materials removed on the project shall remain the property of the Owner and shall be stored in a location on the property designated by the Owner.

All existing electrical equipment, switches, starters, controls, etc., interfering with the new construction, but not being abandoned as part of the project, shall be relocated as may be necessary and/or shown on the drawings.

EXCAVATION, TRENCHING AND BACKFILLING

Contractor shall perform all necessary excavations as required by his underground work, and shall remove whatever substances encountered, to the depths shown on the drawings, or as required by field conditions and directed by the Engineers.

Contractor shall provide all shoring necessary to maintain the banks of their excavations, removing same as the work progresses and the filling in is done.

No excavation for pipe trenching shall be made in filled or disturbed earth until it has finally settled or has been otherwise compacted to properly support general construction.

All trenches shall be dry and clean when conduit is being laid. Any water in trenches shall be pumped dry before installation of conduit.

All conduit lines shall be laid straight and in true alignment with the grade and location established on the drawings, or as directed by the Engineers.

Trenches shall be backfilled and compacted with sand in eight inch layers, compacted to at least 95% of its maximum density as determined by ASTM D1557. Excess excavating material shall be removed from the premises or deposited on the premises where directed.

MOTORS

Unless otherwise noted, all motors shall be provided and installed by other trades for final connections by the Electrical Contractor.

CONDUITS AND FITTINGS

Conduits in mechanical equipment spaces may be run exposed. All other conduit shall be concealed, unless otherwise noted. Exposed conduit shall be installed parallel, or at right angles to adjacent building lines and shall be supported at intervals not exceeding eight feet.

All wiring shall be enclosed in a raceway, unless otherwise noted.

Conduit run exposed and conduit larger than 1" shall be hot-dip galvanized, rigid heavywall type unless otherwise noted.

Conduit 1" and smaller which is concealed in walls or ceiling spaces shall be Electrical Metallic Tubing.

Conduit run in floor, underfloor and underground shall be rigid non-metallic, PVC conduit equal to Carlton Type 40. Provide equipment grounding conductor in each conduit in accordance with N.E.C.

WIRE AND CABLES

All wire and cable shall conform to the latest requirements of the current edition of the NEC and shall meet all ASTM Specifications. Wire and cable shall be new; shall have size, grade of insulation, voltage and manufacturer's name permanently marked on outer covering at regular intervals; shall be delivered in complete coils or reels with identifying size and insulation tags.

All wire and cable shall be #12 AWG stranded, soft-drawn copper, Type THWN or THHN, unless otherwise noted or a higher temperature wire is required to feed lighting fixtures, high temperature cutouts, etc.

WIRING DEVICES

All duplex receptacles shall be 20 ampere, 125 volt, grounding type specification grade and color by owner, as manufactured by Pass and Seymour, Bryant, Hubbell or Arrow-Hart and Hegeman, equal to Catalog No. 5352 Pass and Seymour.

GFI receptacles shall be 20 ampere, 125 volt, 5mA trip grounding type, specification grade, color by owner, as manufactured by Pass & Seymour CAT# 2094 or Bryant, Hubbell or Arrow-Hart. Weatherproof receptacles to have white-in-use covers by Pass & Seymour CAT# WUC10-DCL or Bryant, Hubbell, or Arrow-Hart.

All wall switches single pole, three and four way, shall be 20 ampere, 120/277 volt, ground terminal, specification grade, color by owner, Catalog No. Series 20AC as manufactured by Pass & Seymour or equal to Bryant, Hubbell, Arrow-Hart and Hegeman.

All switch and receptacles plates in occupied spaces shall be thermostat plastic no line "SP" series as manufactured by Pass and Seymour, Hubbell, Bryant, or Arrow-Hart and Hegemen.

All switch and receptacles plates in unoccupied spaces shall be .040 stainless steel; 97,000 series as manufactured by Pass and Seymour, Hubbell, Bryant, or Arrow-Hart and Hegemen.

Absolutely no despard switches shall be used unless otherwise specified or unless necessary due to building construction; and then only if specifically approved by the Engineer.

SURFACE METAL RACEWAY

Provide two piece surface mounted, grey enamel finished, metal raceway, divide to separate branch circuits and phone/data cables. Provide necessary connection accessories for a complete raceway system. Wiremold series 4000 or equal.

DISCONNECT SWITCHES

Provide and install all required fusible or non-fusible disconnect switches shown on the drawings. All switches shall be heavy duty type in a NEMA 1 enclosure when mounted indoors, or a NEMA 3R enclosure when mounted outdoors. Switches shall be quick-make, quick-break with a mechanical dual cover interlock. Disconnect switches shall be Square D, G.E. or Cutler Hammer.

MANUAL MOTOR STARTER

Fractional single phase motor starters shall be toggle switch type with red running light. Properly sized overloads and NEMA Type 1 enclosure. Units shall be Square D Class 2510, G.E. or Cutler Hammer.

FUSES

All fuses shall be dual element cartridge type and shall have a minimum short-circuit rating of 100,000 rms amps. Fuses shall be Bussman "Fusetron."

Fuses for all circuit, motors, and other equipment shall be selected in ratings in accordance with the National Electrical Code, to provide a coordinated system of over-current protection. Thus in case of a fault or harmful overload, only the fuses nearest the fault or overload equipment shall open. Fuses selected for branch circuit protection of motors with other thermal overload protection shall not be rated at greater than 150% of full load motor current.

LAMPS

All linear fluorescent lamps to be medium bipin T-8 wattage as indicated on drawings, 78 color rendering index, 4100 K color temperature, 20000 hours rated life, 25 deg. C rated operating temperature and pass the Federal Toxic Characteristic Leaching Procedure.

All metal halide lamps to be mogul base, multi-vapor, 65 color rendering index, 4000 K color temperature, and uncoated.

BALLASTS

Ballast shall be rapid start with voltage rating as indicated on drawing at 60Hz, and high frequency type operating lamps above 20KHz. Lamp Current Crest Factor shall be 1.7 or less and Ballast Factor greater than 0.85 in accordance with lamp manufacturer recommendation and ANSI C82.11-1993. Total Harmonic Distortion shall be less than 10% and have a power factor greater than 0.97.

Ballasts shall operate lamps with no visible flicker, shall operate at 72 degrees Fahrenheit and have a starting temperature of 0 degrees Fahrenheit.

Any ballast that develops a noticeable hum or become inoperative during the Contract Guarantee period, then the ballast and fuse shall be replaced in the fixture and connected for a complete operation at no additional cost to the Owner.

BRANCH CIRCUIT PANELBOARDS

Lighting Panelboards, Circuit Breaker Type, 120/208 Volt, 3 Phase, 4 Wire:

a. Shall be dead front, Square D type NQOB or equal to G.E., or Cutler Hammer with flush or surface mounted steel cabinet as required and an integral assembly of circuit breakers. Trims shall have hinged and locked doors with glass or heavy plastic covered circuit directories. All locks shall be keyed alike. Boxes shall be galvanized, and front assembly shall be painted with a prime and finish coat of manufacturer's standard finish. All flush mounted panels shall be approximately 5-3/4" deep and 20" wide. Panels shall have 3 phase, 4 wire, solid neutral mains of capacities indicated on the drawings with main lugs or main circuit breaker as required.

b. Circuit breakers shall be molded plastic case type, AC-DC rated, 1, 2, or 3 pole as required, quick-make, quick-break, with trip free operating handle, position indication and thermal-magnetic trip device, temperature compensation, bolted type, with toggle switching action to be independent of tripping action. Provide magnetic trip action device for all motor circuit, 2 and 3 pole breakers shall have a common operating handle and common trip mechanism. Trip ratings shall be as indicated on the drawings and minimum interrupting capacity shall be 10000 rms symmetrical amperes at 240 volts.

c. Lugs for mains shall be solderless type.

MANUALS AND BROCHURES

Upon completion of work furnish Owner with four sets of manufacturer's instruction books, maintenance brochures, descriptive brochures, and spare parts brochures for equipment listed in the specification. One complete set shall be bound into book form for the Owner's use.

RECORD DRAWINGS

The Contractor shall keep in its field office, one copy of all drawings, specifications, shop drawings, and changes available for reference by the Owner and Architects reflecting an accurate and up-to-date record of actual construction whether or not covered by official revisions to drawings and specifications.

Record drawings shall consist of separate plans for lighting systems, receptacle systems, power systems, communication systems, riser diagrams, etc. Each system drawing shall show location, size and conductor fill for all conduits, junction boxes and outlets.

At completion, the Contractor shall furnish to the Owner one (1) complete set of contract sepia, neatly marked and dimensioned where required to show all variations between actual construction as built and work as indicated on the printed drawings, including all changes in locations, sizes, depth, elevations, etc. Particular care shall be taken to fully dimension all concealed and underground work performed under the Contract. These sepia shall be new sets purchased from the Architect, each sheet certified as built by the Contractor, and turned over to the Owner in good condition.

SHOP DRAWINGS

Submit shop drawings in accordance with the requirements of the Contract conditions and Division 1 of these specifications.

Check shop drawings for coordination with the work of other trades and conformity with the contract drawings and specifications before submitting them to the Architect-Engineer; note any and all variations and affix Contractor's approval stamps. Where more than one piece of equipment is shown on the shop drawing, the equipment to be supplied shall be marked.

Drawings or catalog cuts marked "resubmit as noted" or "rejected" must be corrected and returned for final checking. No shop drawings or catalog cuts shall be used on the work unless marked "no exceptions" or "exceptions as noted" by the Engineers. Three copies of all drawings and catalog cuts submitted will be retained by the Engineers. Contractor shall submit as many more copies as he desires returned. The Contractor shall furnish to the field, prints of shop drawings and catalog cuts marked "no exceptions" or "exceptions as noted" as required by the construction operations.

After shop drawings have been submitted to the engineer and returned to the Contractor marked "no exceptions" or "exceptions as noted", the Contractor will not be allowed to resubmit shop drawings of another manufacturer, for the same item, without the engineers consent.

Shop drawings required shall include but not necessarily be limited to the following:


- light fixtures
- disconnect switches
- motor starters
- circuit breakers
- panelboards
- emergency power system
- lighting control system
- fire alarm system

TEMPORARY POWER AND LIGHTING

Provide temporary power and lighting as required for construction.

Cost of current consumed will be paid by the Owner.

The Electrical Contractor shall perform his work in accordance with any applicable safety laws, rules, or regulations of the State of Michigan.

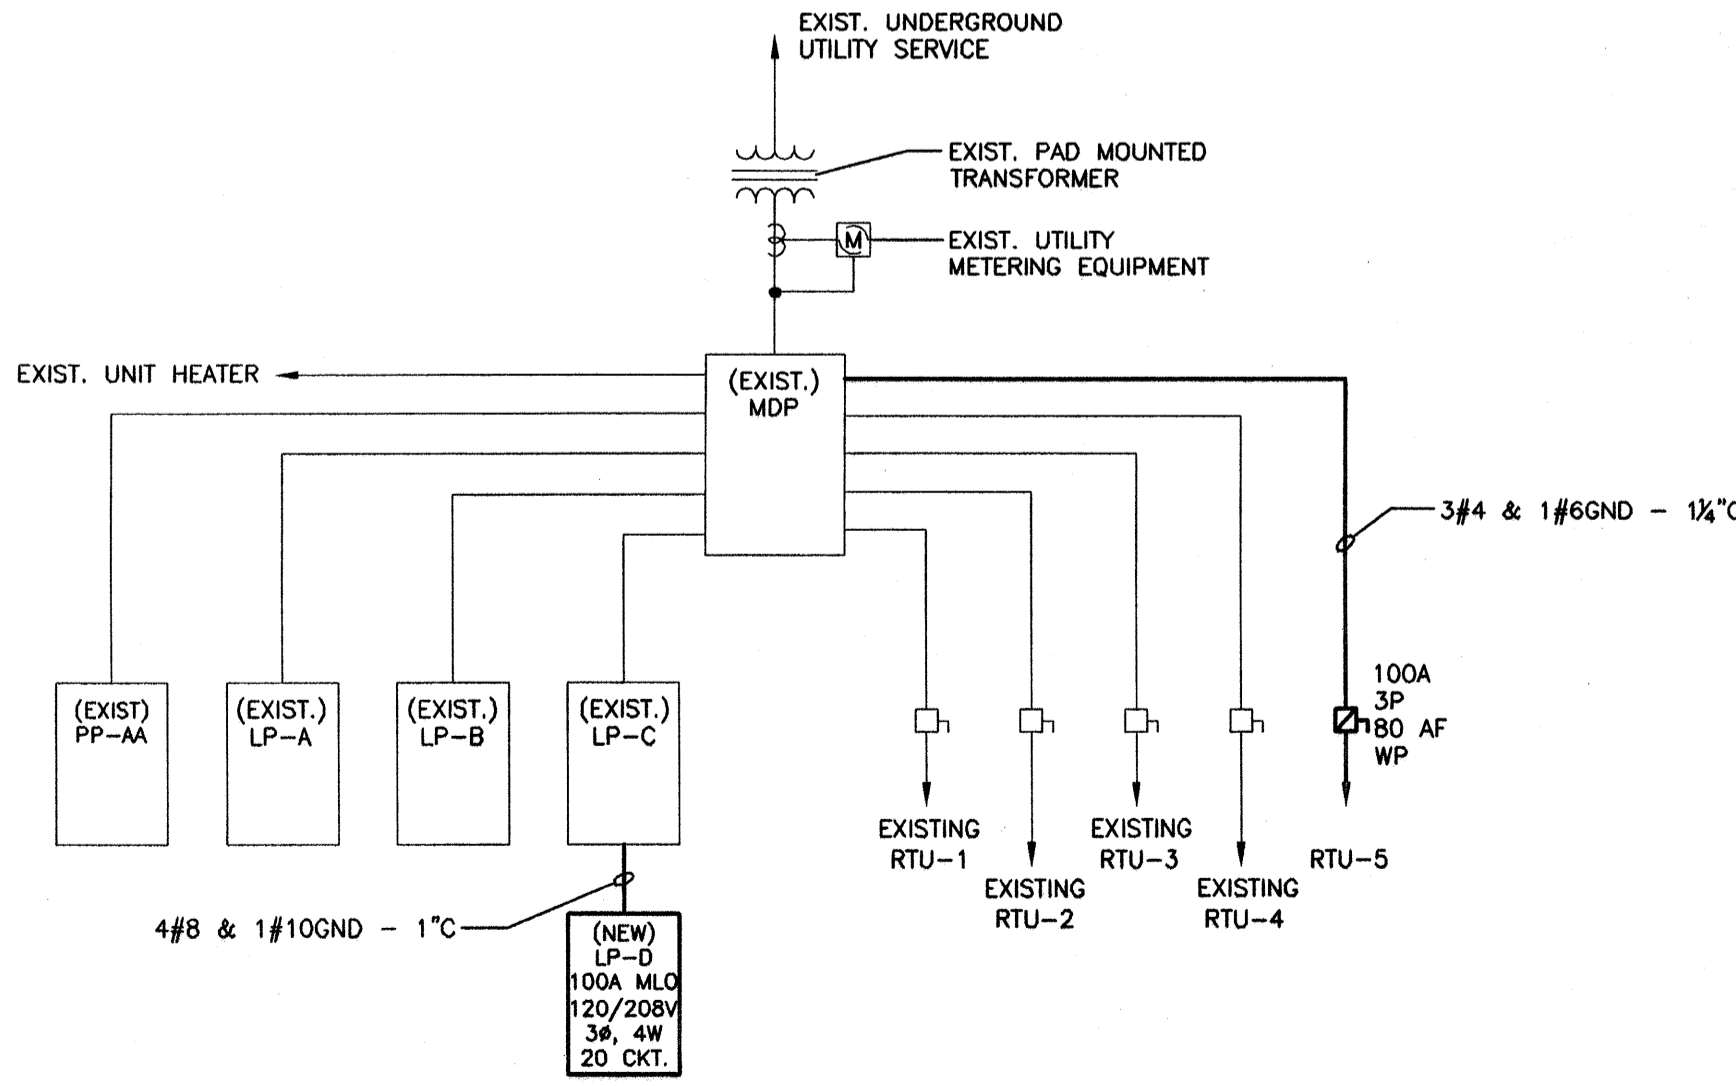

ELECTRICAL RISER DIAGRAM SCALE: NOT TO SCALE

PREPARED UNDER THE SUPERVISION OF:

PROJECT LOG

ISSUED FOR REVIEW

FILE: 50741.0001/E1 PROJECT MGR: MRC DESIGNED BY: MRC DRAWN BY: DGH CHECKED BY: NOT TO SCALE SHEET: E2 OF 2

OWNER:

MULTI-PURPOSE ROOM ADDITION ACADEMY OF WARREN

13943 E. EIGHT MILE RD. WARREN, MICHIGAN 48089

CHARTER SCHOOL ADMINISTRATION SERVICES 20755 GREENFIELD RD. SUITE 300 SOUTHFIELD, MICHIGAN 48075 (248) 789-4401

ELECTRICAL SPECIFICATIONS

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E2

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